


NORTH ELEVATION 1/4"=1'-0"

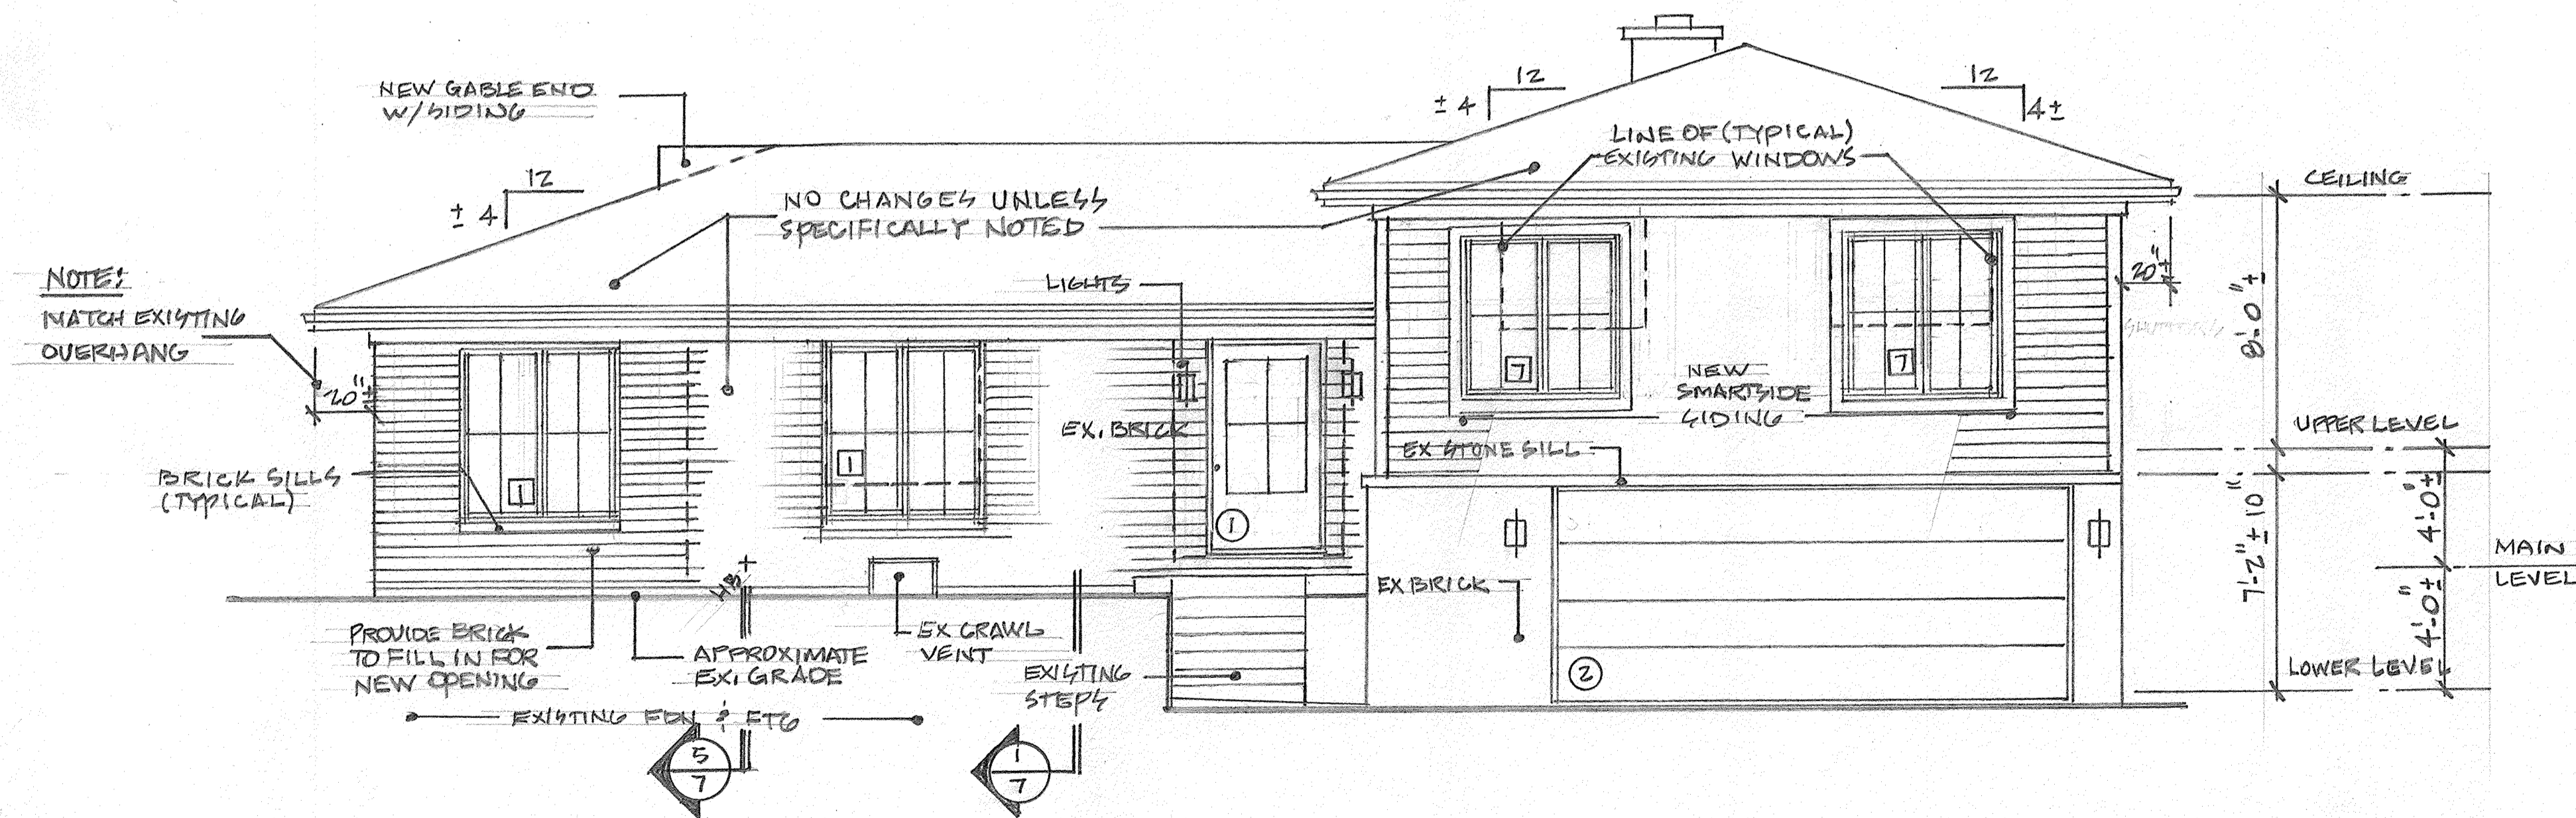

SOUTH ELEVATION 1/4"=1'-0"

Geneva Building Codes & Ordinances

- 2015 International Residential Building Code
- 2018 International Energy Conservation Code
- 2014 National Electric Code
- Current State of Illinois Plumbing Code
- 2015 International Mechanical Code
- 2015 International Fuel Gas Code
- 2015 International Fire Code

Schedule of Drawings


1. Exterior elevations, Building codes
2. Exterior elevations
3. Main/Lower Level Floor Plan, Upper Level Floor Plan—Architectural
4. Main/Lower Level Floor Plan, Upper Level Floor Plan—Electrical/Structural
5. Foundation Floor Plan, Roof Plan
6. Schedules, Radon drawing, Wall Bracing Details, General notes, Miscellaneous details
7. Wall sections, Plumbing isometrics, Wood Deck Details
8. Existing— Exterior Elevations
9. Existing— Main/Lower Level Floor Plan, Upper Level Floor Plan
10. Existing— Foundation Floor Plan, Roof Plan

State of Illinois  
 Nicholas R. DeLuca  
 001.006810  
 Licensed architect


Nicholas DeLuca  
 8/28/20 Ag 11/30/20

Issued for permit:	Issued for construction:
<b>ND</b> Nicholas R. DeLuca 1807 West Diehl Road, Suite 200 Naperville, IL 60563	architect (630) 637-8213
REMODEL & ADDITION	
SUE & BOB ROLES	
25 FULTON STREET GENEVA, IL.	project number: 202026 prepared by: ND date: 8/28/20
BUILDER	
RITEWAY CUSTOM HOMES 540DUANE AVENUE GLENELLYN, IL	
sheet number: <b>1</b> OF 10	



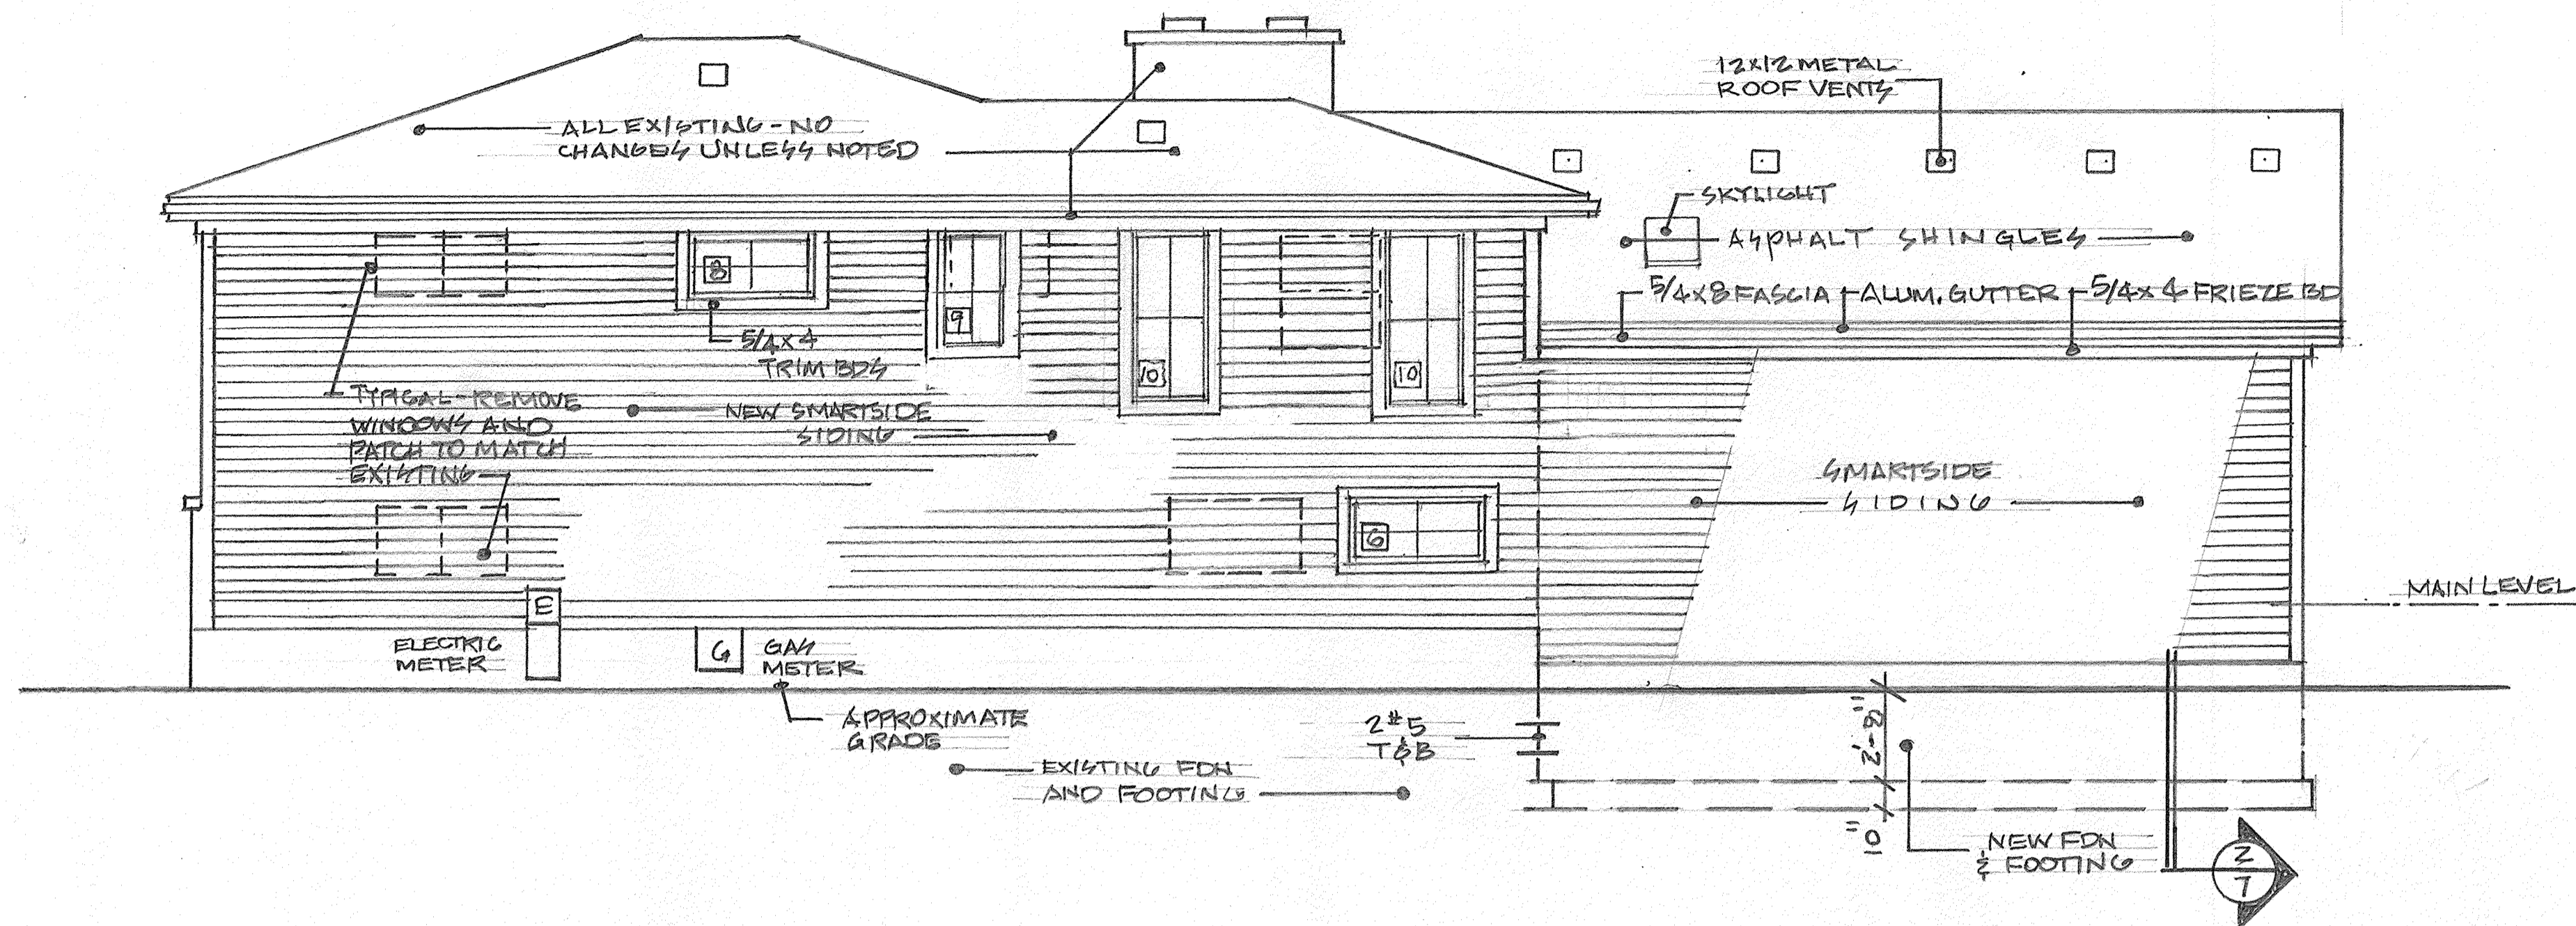

EAST ELEVATION 1/4"=1'-0"

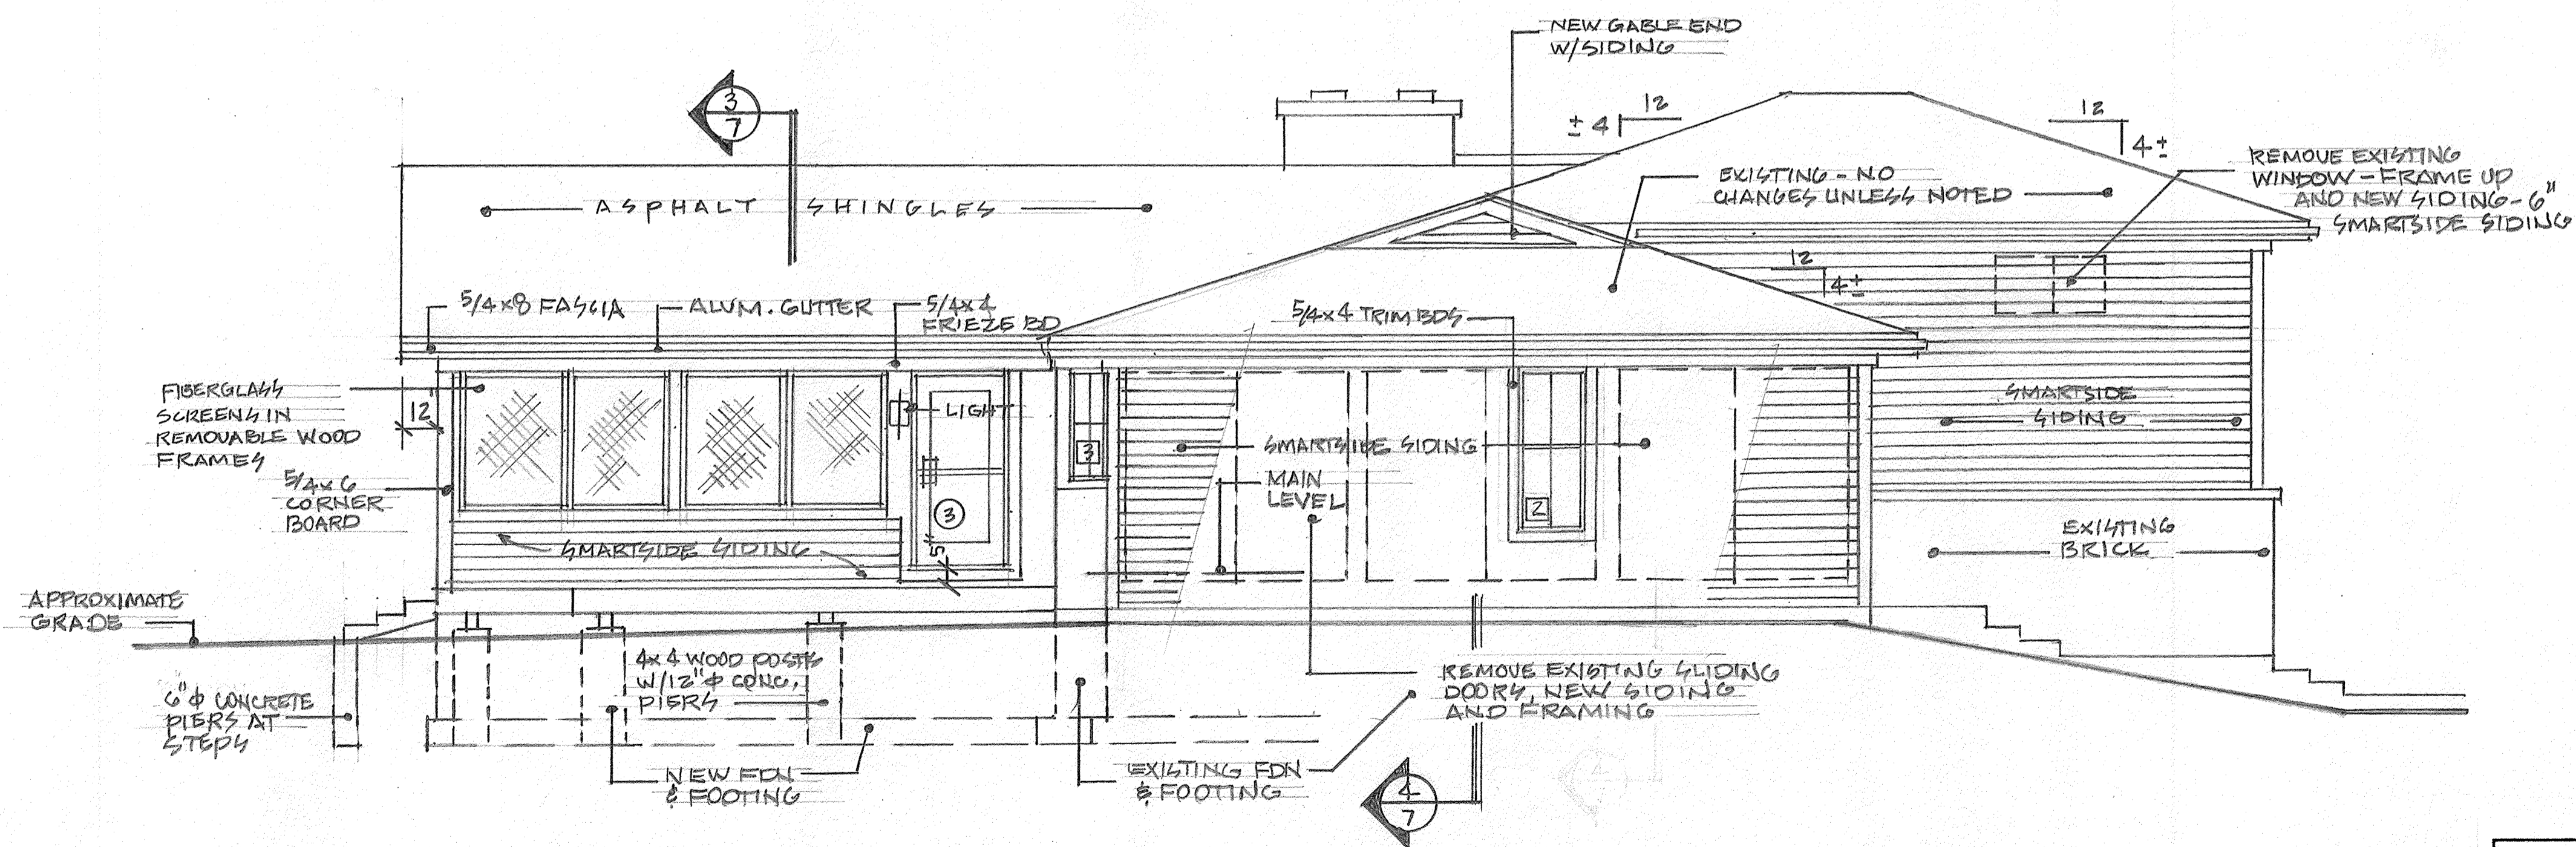


WEST ELEVATION 1/4"=1'-0"

State of Illinois  
 Nicholas R. DeLuca  
 001.006810  
 Licensed architect

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<b>ND</b> Nicholas R. DeLuca 1807 West Diehl Road, Suite 200 Naperville, IL 60563 (630) 637-8213	architect
REMODEL & ADDITION SUE & BOB ROLES 25 FULTON STREET GENEVA, IL.	project number: 202026 prepared by: ND date: 8/28/20
EXTERIOR ELEVATIONS	sheet number: <b>2</b> OF 10



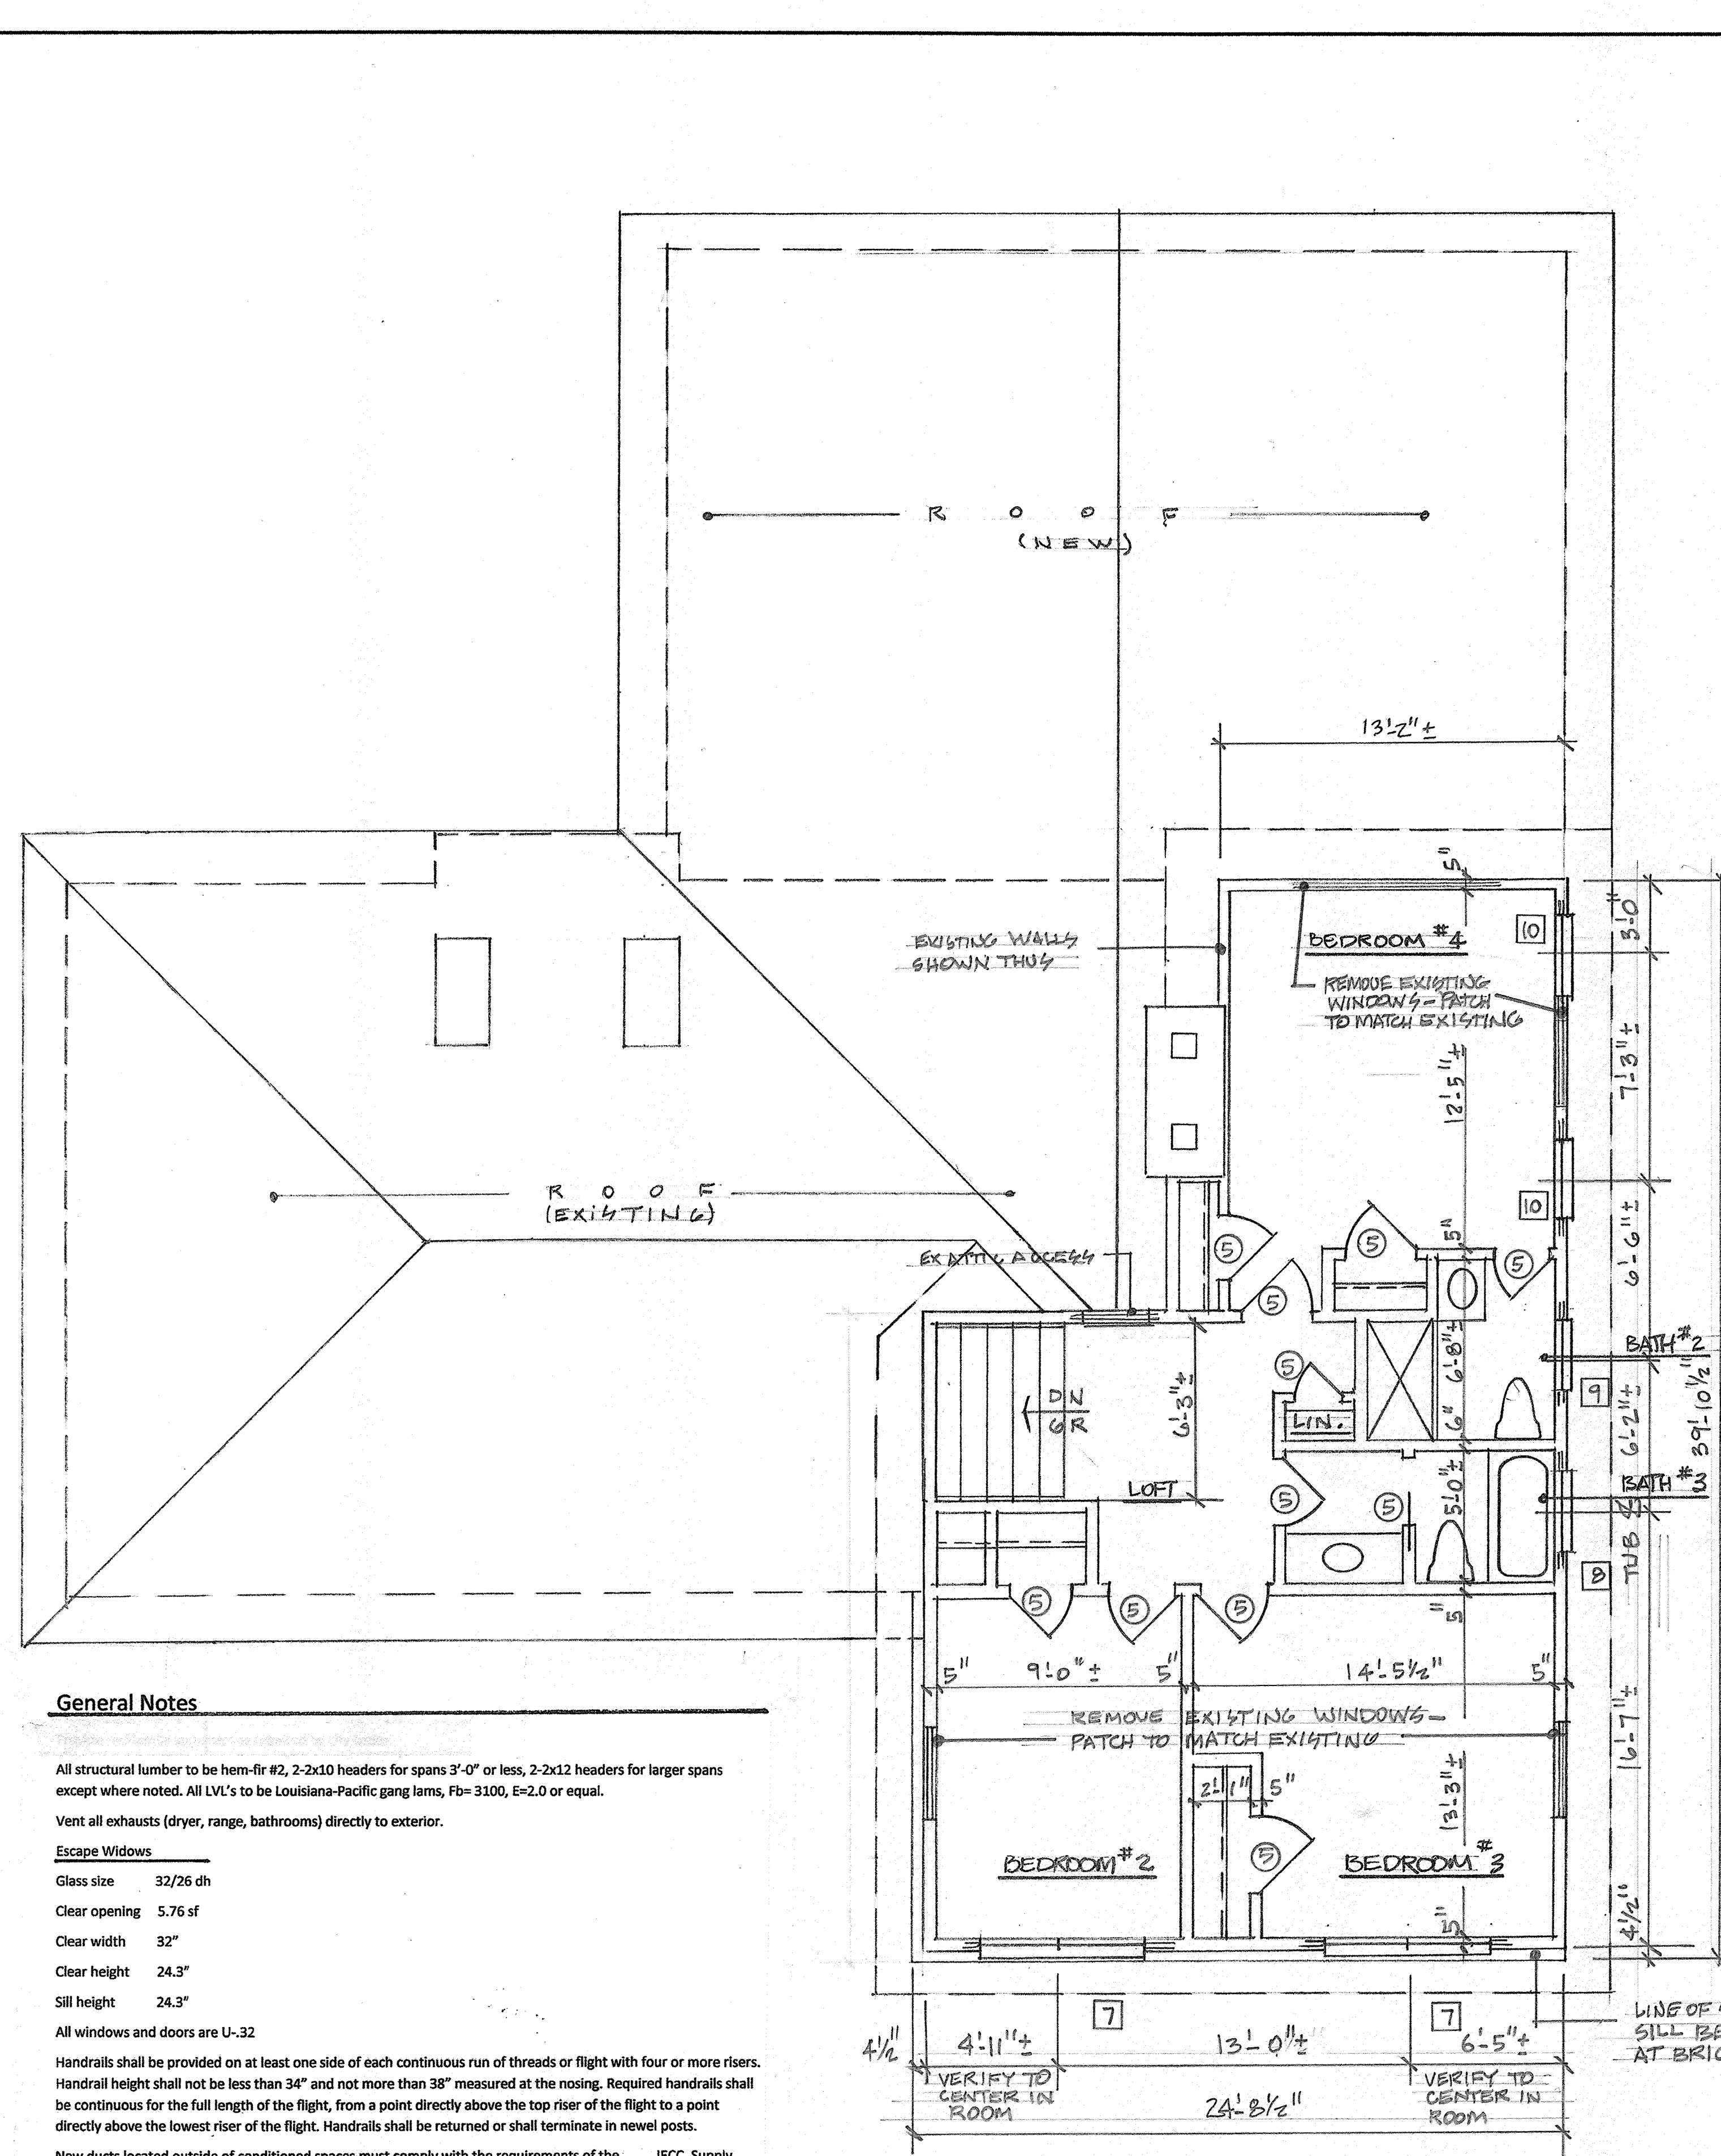

**General Notes**

All structural lumber to be hem-fir #2, 2-2x10 headers for spans 3'-0" or less, 2-2x12 headers for larger spans except where noted. All LVL's to be Louisiana-Pacific gang lams, Fb=3100, E=2.0 or equal.

Vent all exhausts (dryer, range, bathrooms) directly to exterior.

**Escape Windows**


Glass size 32/26 dh  
 Clear opening 5.76 sf  
 Clear width 32"  
 Clear height 24.3"  
 Sill height 24.3"

All windows and doors are U-32

Handrails shall be provided on at least one side of each continuous run of threads or flight with four or more risers. Handrail height shall not be less than 34" and not more than 38" measured at the nosing. Required handrails shall be continuous for the full length of the flight, from a point directly above the top riser of the flight to a point directly above the lowest riser of the flight. Handrails shall be returned or shall terminate in newel posts.

New ducts located outside of conditioned spaces must comply with the requirements of the IECC. Supply ducts in attics shall be insulated to a minimum of R-8. All other ducts shall be insulated to a minimum of R-6.


At all locations of exposed insulation, the insulation facing shall have a flame spread rating of under 25 and a smoke development factor of under 400.

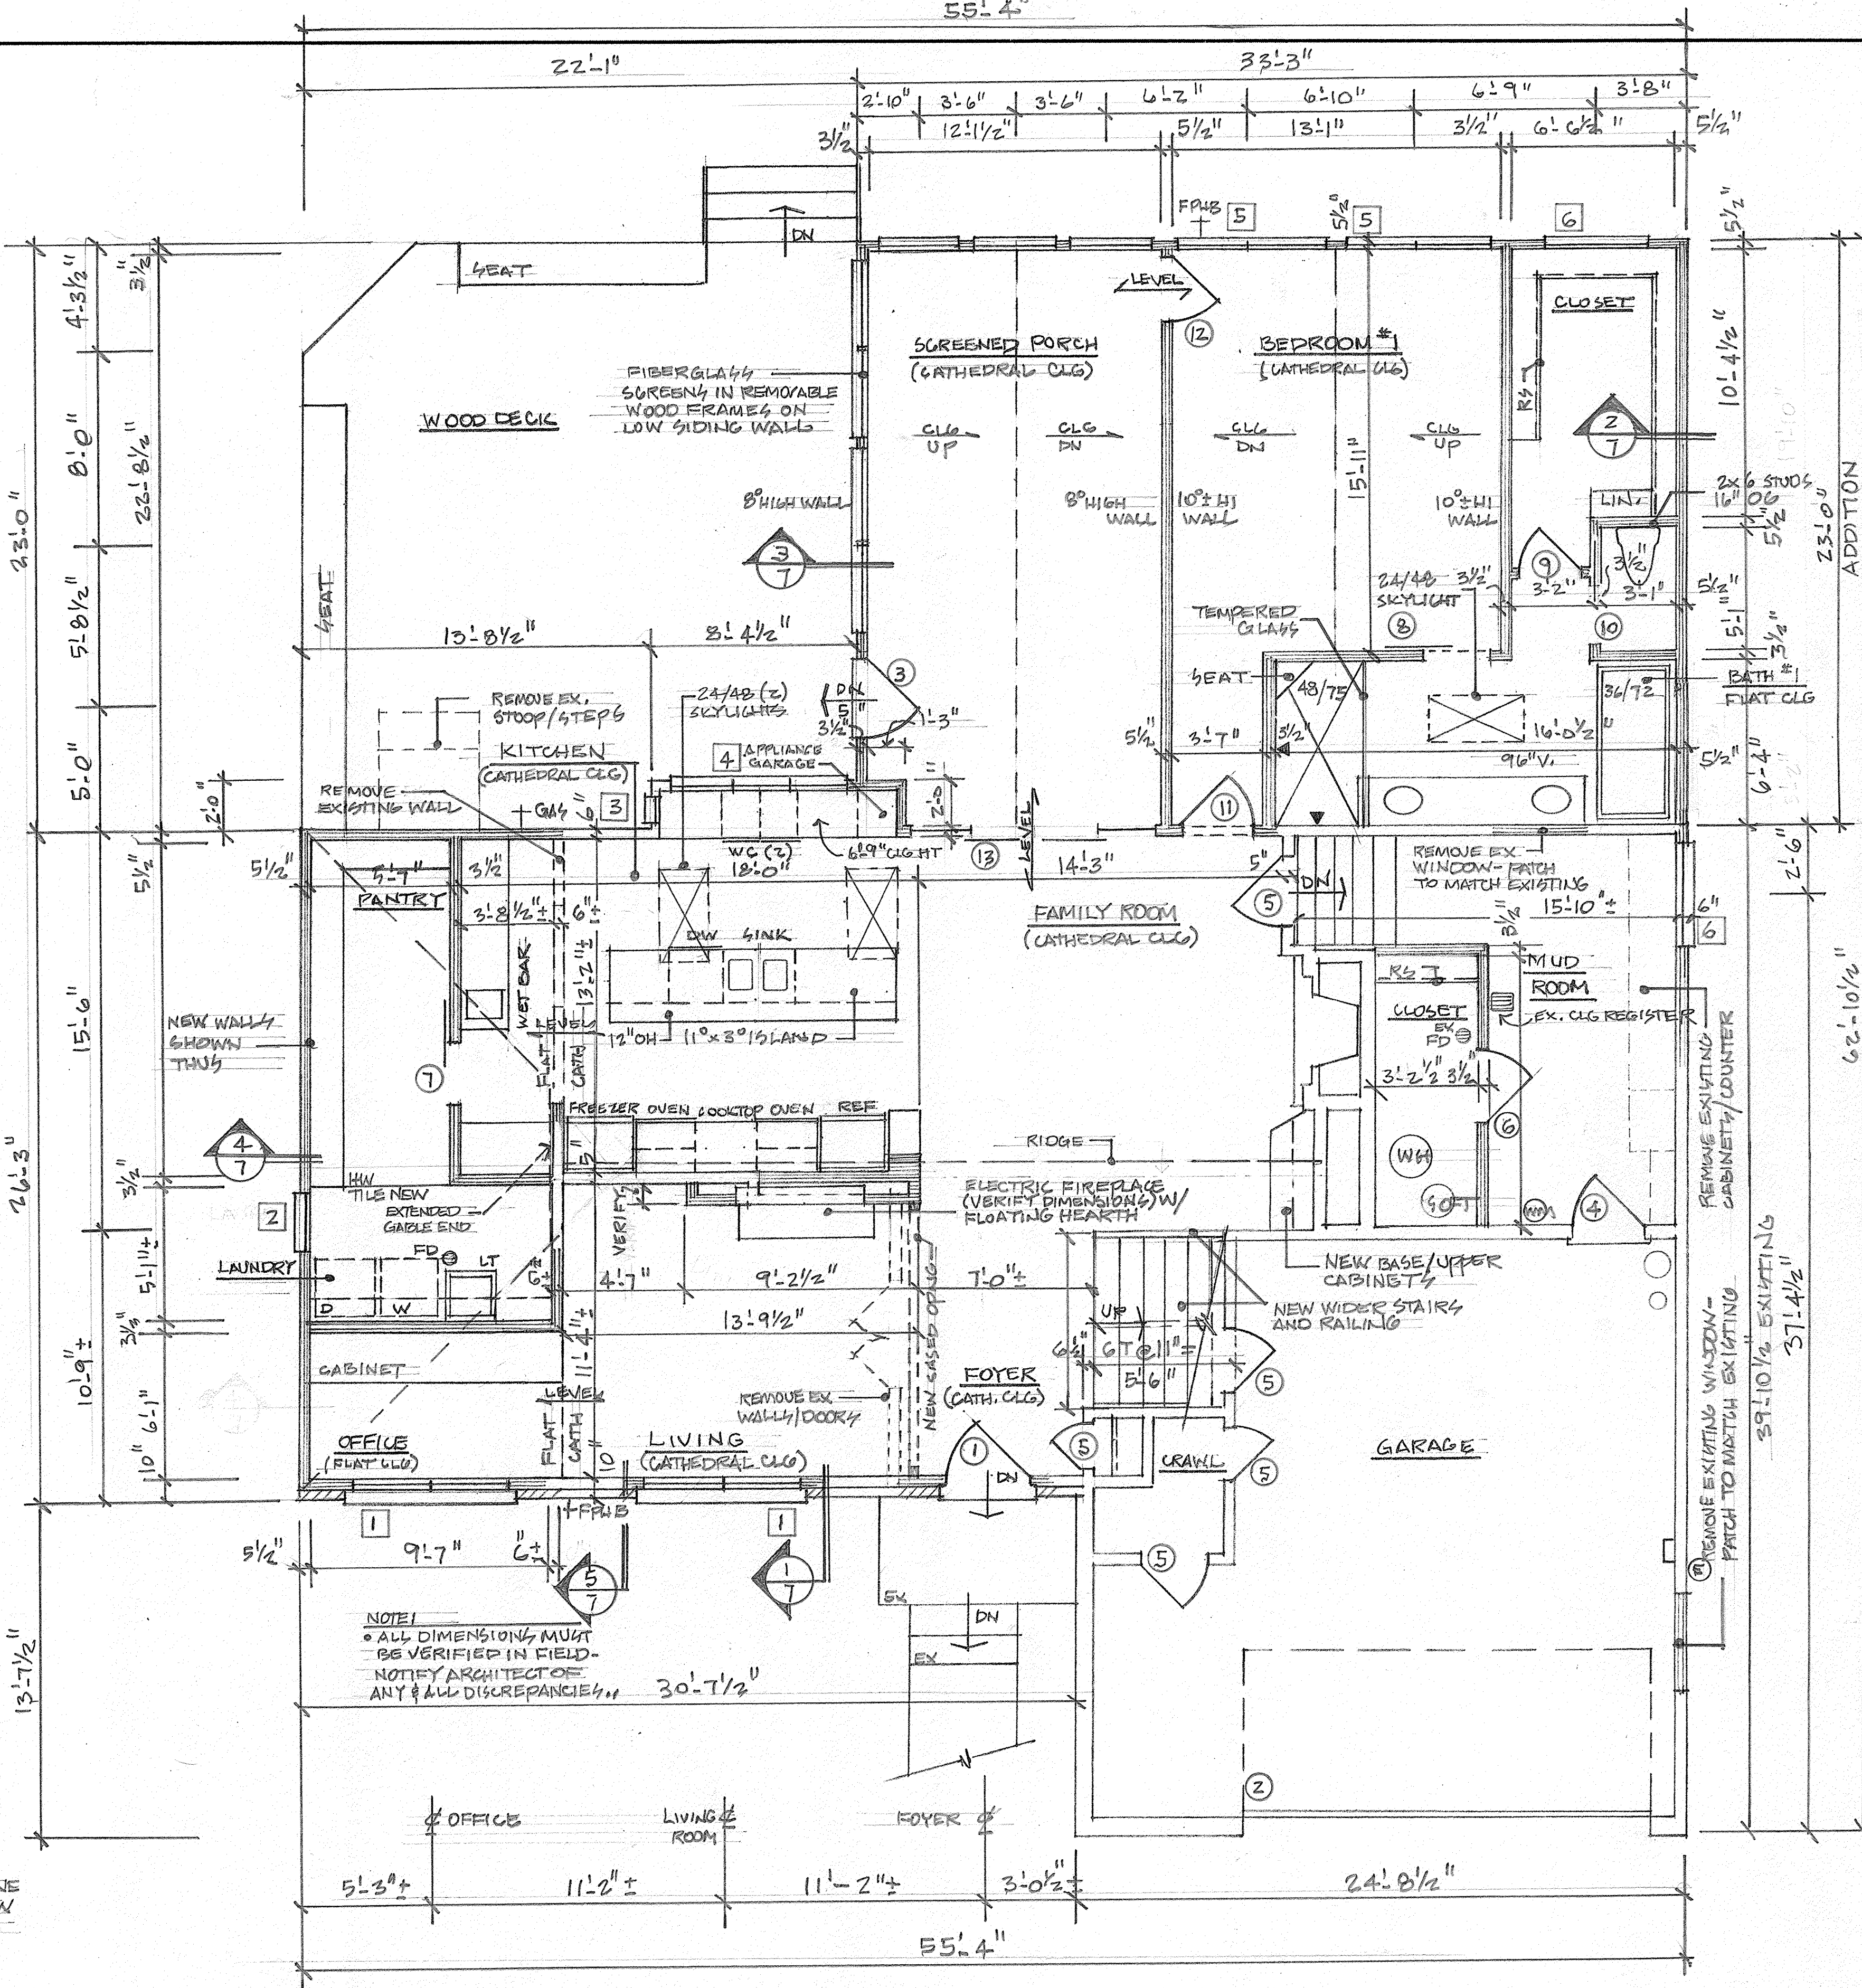

**NOTE**  
 • ALL DIMENSIONS MUST BE VERIFIED IN FIELD - NOTIFY ARCHITECT OF ANY & ALL DISCREPANCIES


**UPPER LEVEL FLOOR PLAN 1/4"=1'-0"**  
 ■ 8'-0" CEILING HT.

**MAIN & LOWER LEVEL FLOOR PLANS 1/4"=1'-0"**  
 ■ MAIN LEVEL 8'-0" CLO. HT.,  
 ■ LOWER LEVEL 7'-2" CLO. HT.

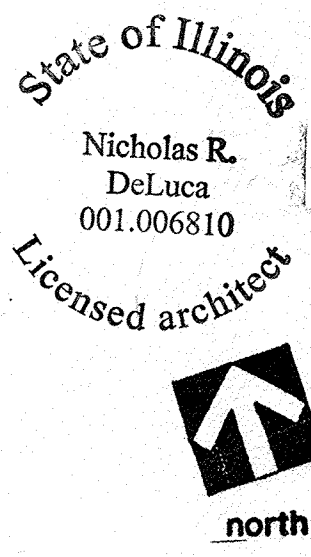

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<b>ND</b> Nicholas R. DeLuca 1807 West Dixie Road, Suite 200 Naperville, IL 60563 (630) 637-8213	architect (630) 637-8213
PROJECT NUMBER: 202026 SUE & BOB BOLES 25 FULTON STREET GENEVA, IL.	PROJECT NUMBER: 202026 PREPARED BY: ND DATE: 8/28/20 SHEET NUMBER: 3 OF 10



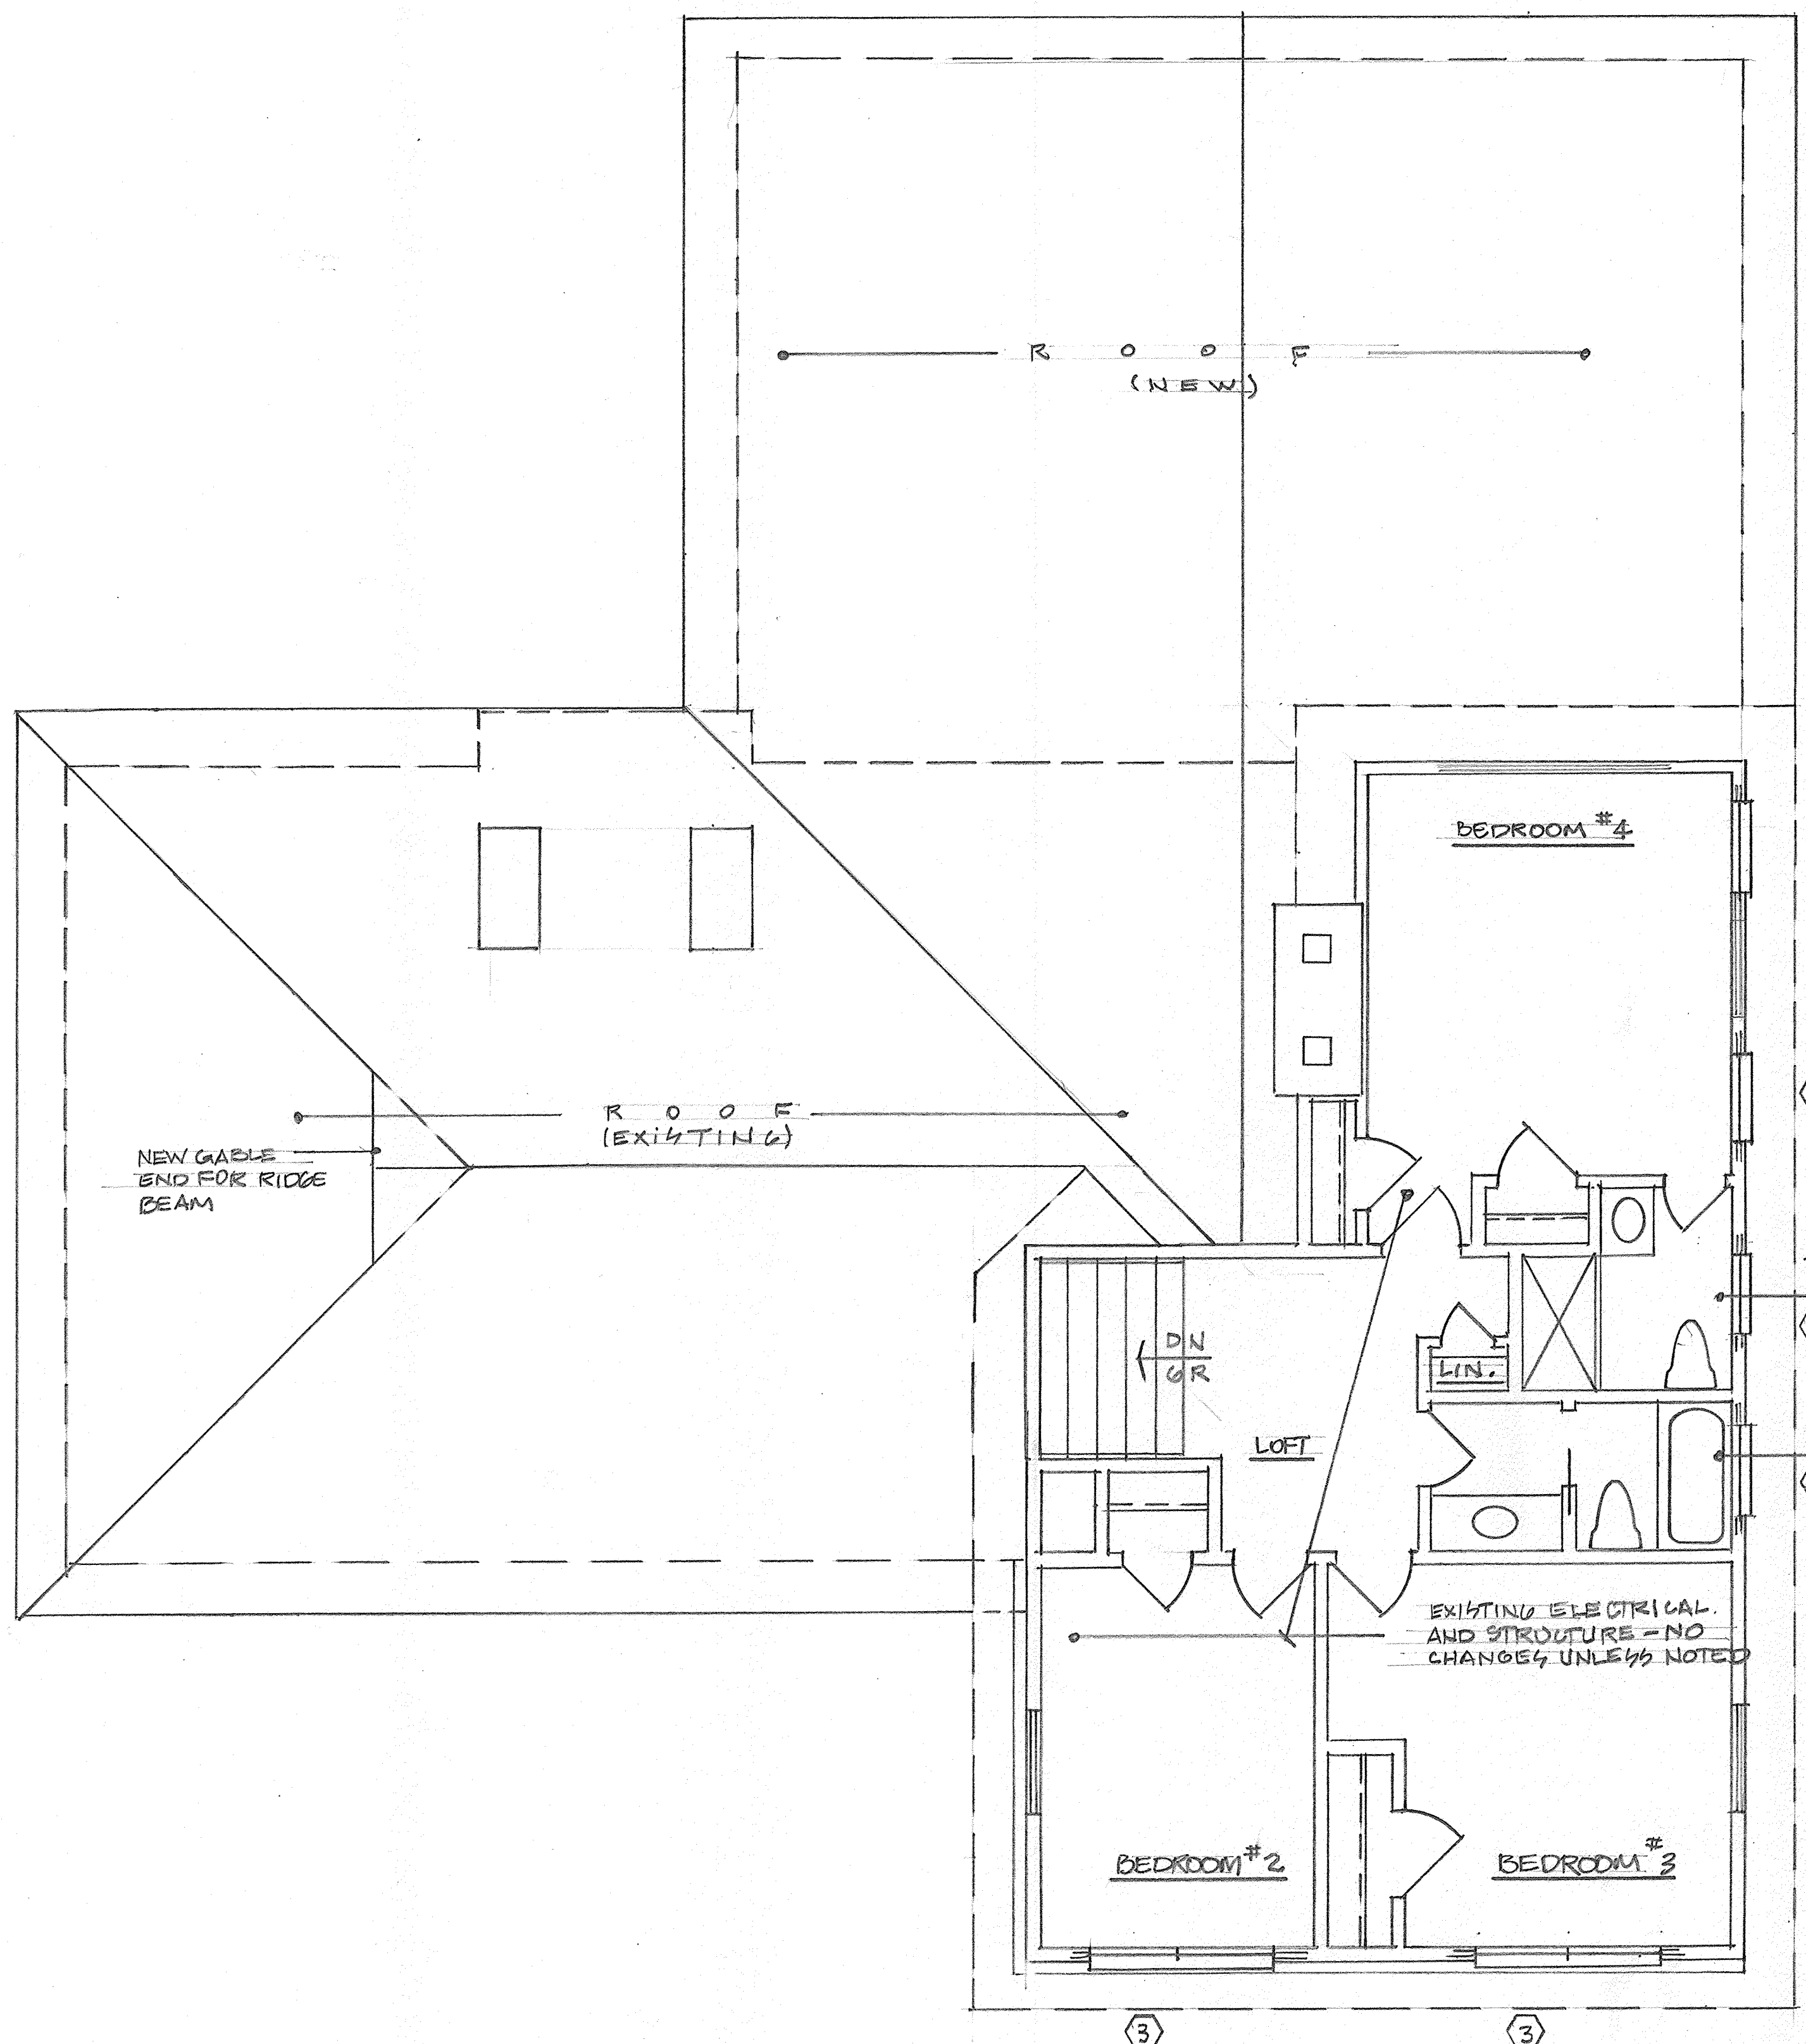

UPPER LEVEL FLOOR PLAN 1/4"=1'-0"  
 ■ 8'-0" CEILING HT.

**HEADER SCHEDULE**

①	EXISTING - NO CHANGES
②	2 - 2x10
③	2 - 2x12
④	2 - 1 3/4" x 9 1/4" LVL
⑤	3 - 1 3/4" x 1 1/4" LVL
⑥	2 - 1 3/4" x 1 1/4" LVL
⑦	

**Electrical Notes**

A minimum 90% of lamps in permanently installed fixtures to be high efficiency.

All 120 volt single phase, 15- and 20- ampere branch circuits supplying outlets installed in dwellings in family rooms, dining rooms, living rooms, parlors, libraries dens, bedrooms, sunrooms, recreation rooms, closets hall ways or similar rooms or areas shall be protected by a listed arc-fault circuit interrupter, combination-type, installed to provide protection of the branch circuit.


All receptacles shall be listed tamper resistant receptacles.

Reinforcing steel in the footing/foundation shall comply with requirements for a concrete encased electrode.

A minimum of two dedicated 20 amp branch circuits must be provided to serve convenience receptacles in the kitchen, pantry, breakfast, and dining areas, and at the kitchen countertops.

All outlets to be a minimum of 12" above the floor line

All wall switches to be a minimum of 48" above the floor line.

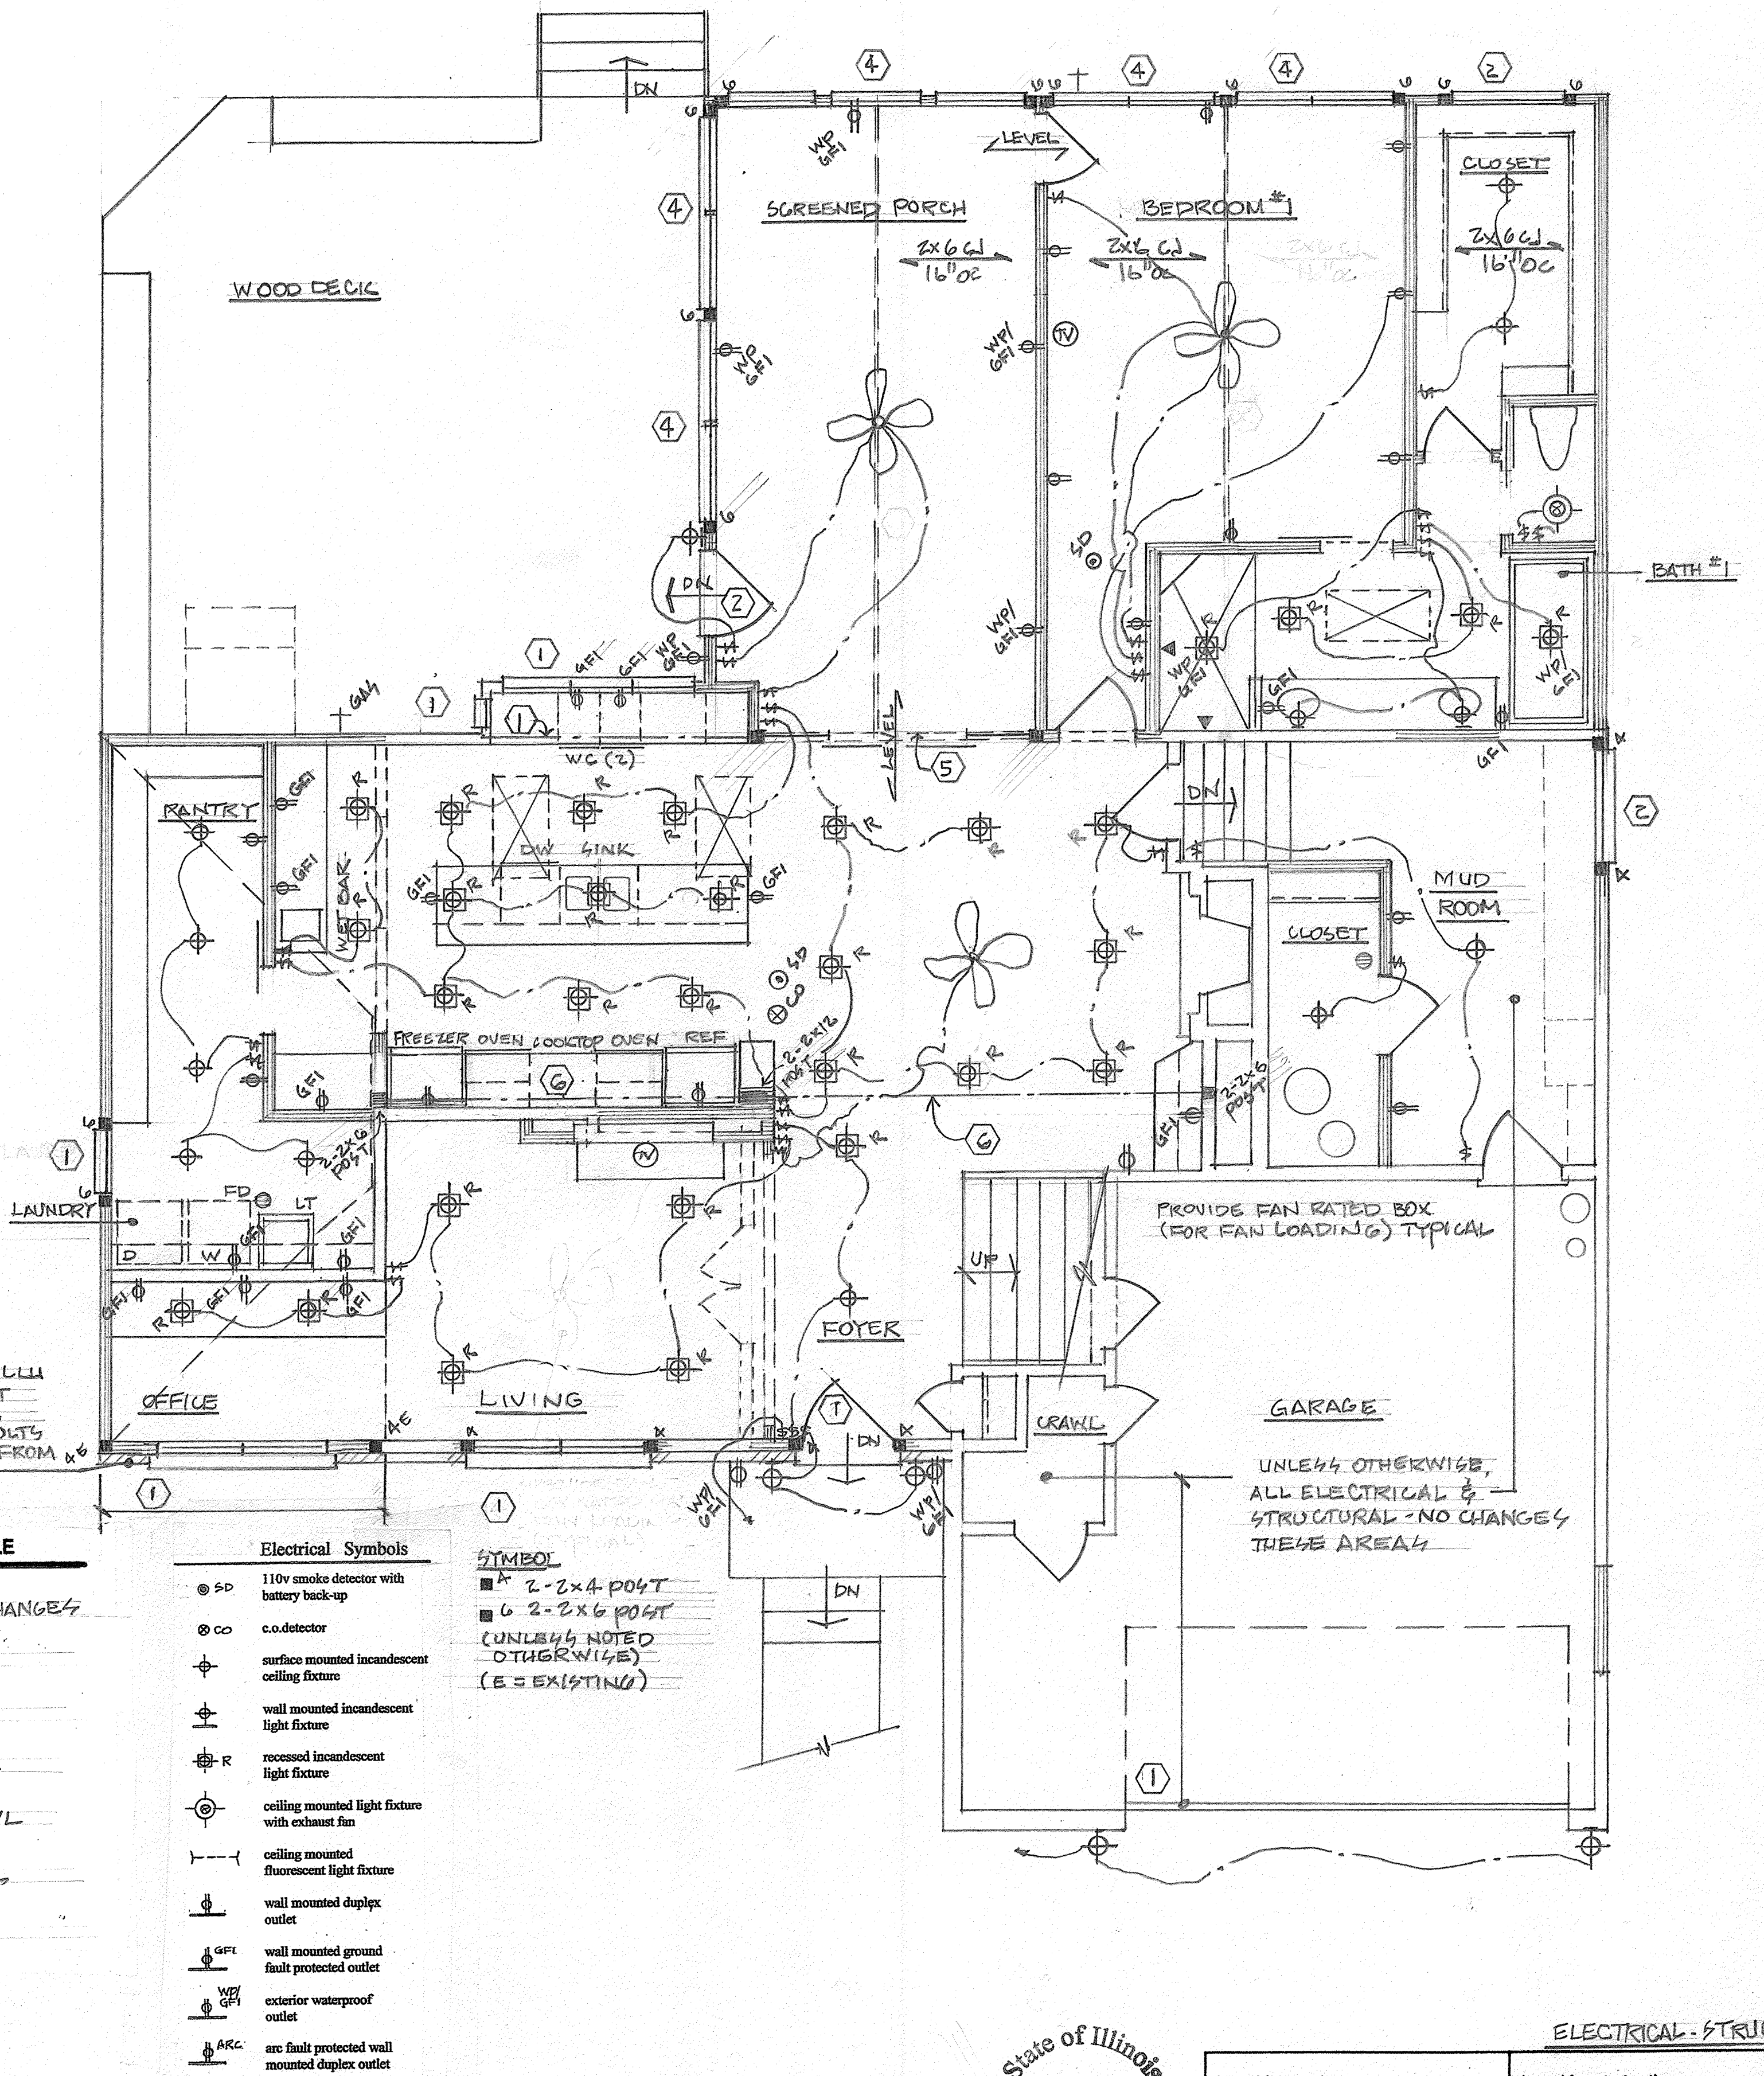

MAIN & LOWER LEVEL FLOOR PLANS 1/4"=1'-0"


**Electrical Symbols**

- SD 110v smoke detector with battery back-up
- CD c.o. detector
- ⊕ surface mounted incandescent ceiling fixture
- ⊕ wall mounted incandescent light fixture
- ⊕ R recessed incandescent light fixture
- ⊕ ceiling mounted light fixture with exhaust fan
- ⊕ ceiling mounted fluorescent light fixture
- ⊕ wall mounted duplex outlet
- ⊕ GFC wall mounted ground fault protected outlet
- ⊕ WFO exterior waterproof outlet
- ⊕ ARC arc fault protected wall mounted duplex outlet

**SYMBOL**

- 2-2x4 POST
- 6-2x6 POST (UNLESS NOTED OTHERWISE) (E = EXISTING)

■ MAIN LEVEL 8'-0" CLO HT.  
 ■ LOWER LEVEL 7'-2" CLO HT.

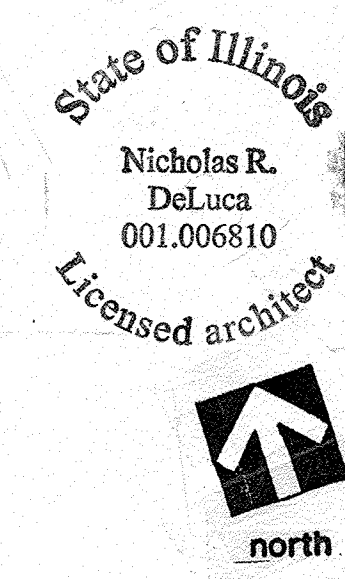

State of Illinois  
 Nicholas R. DeLuca  
 001.006810  
 Licensed architect

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 1807 West Diehl Road, Suite 200 Naperville, IL 60563 • (630) 637-8213 architect


Issued for construction:

project number: 202026  
 prepared by: ND  
 date: 8/28/20  
 sheet number: 4 OF 10


REMODEL & ADDITION  
 SUE & BOB ROLES  
 25 FULTON STREET GENEVA, IL.

ELECTRICAL/STRUCTURAL - MAIN & LOWER LEVEL PLAN UPPER LEVEL PLAN



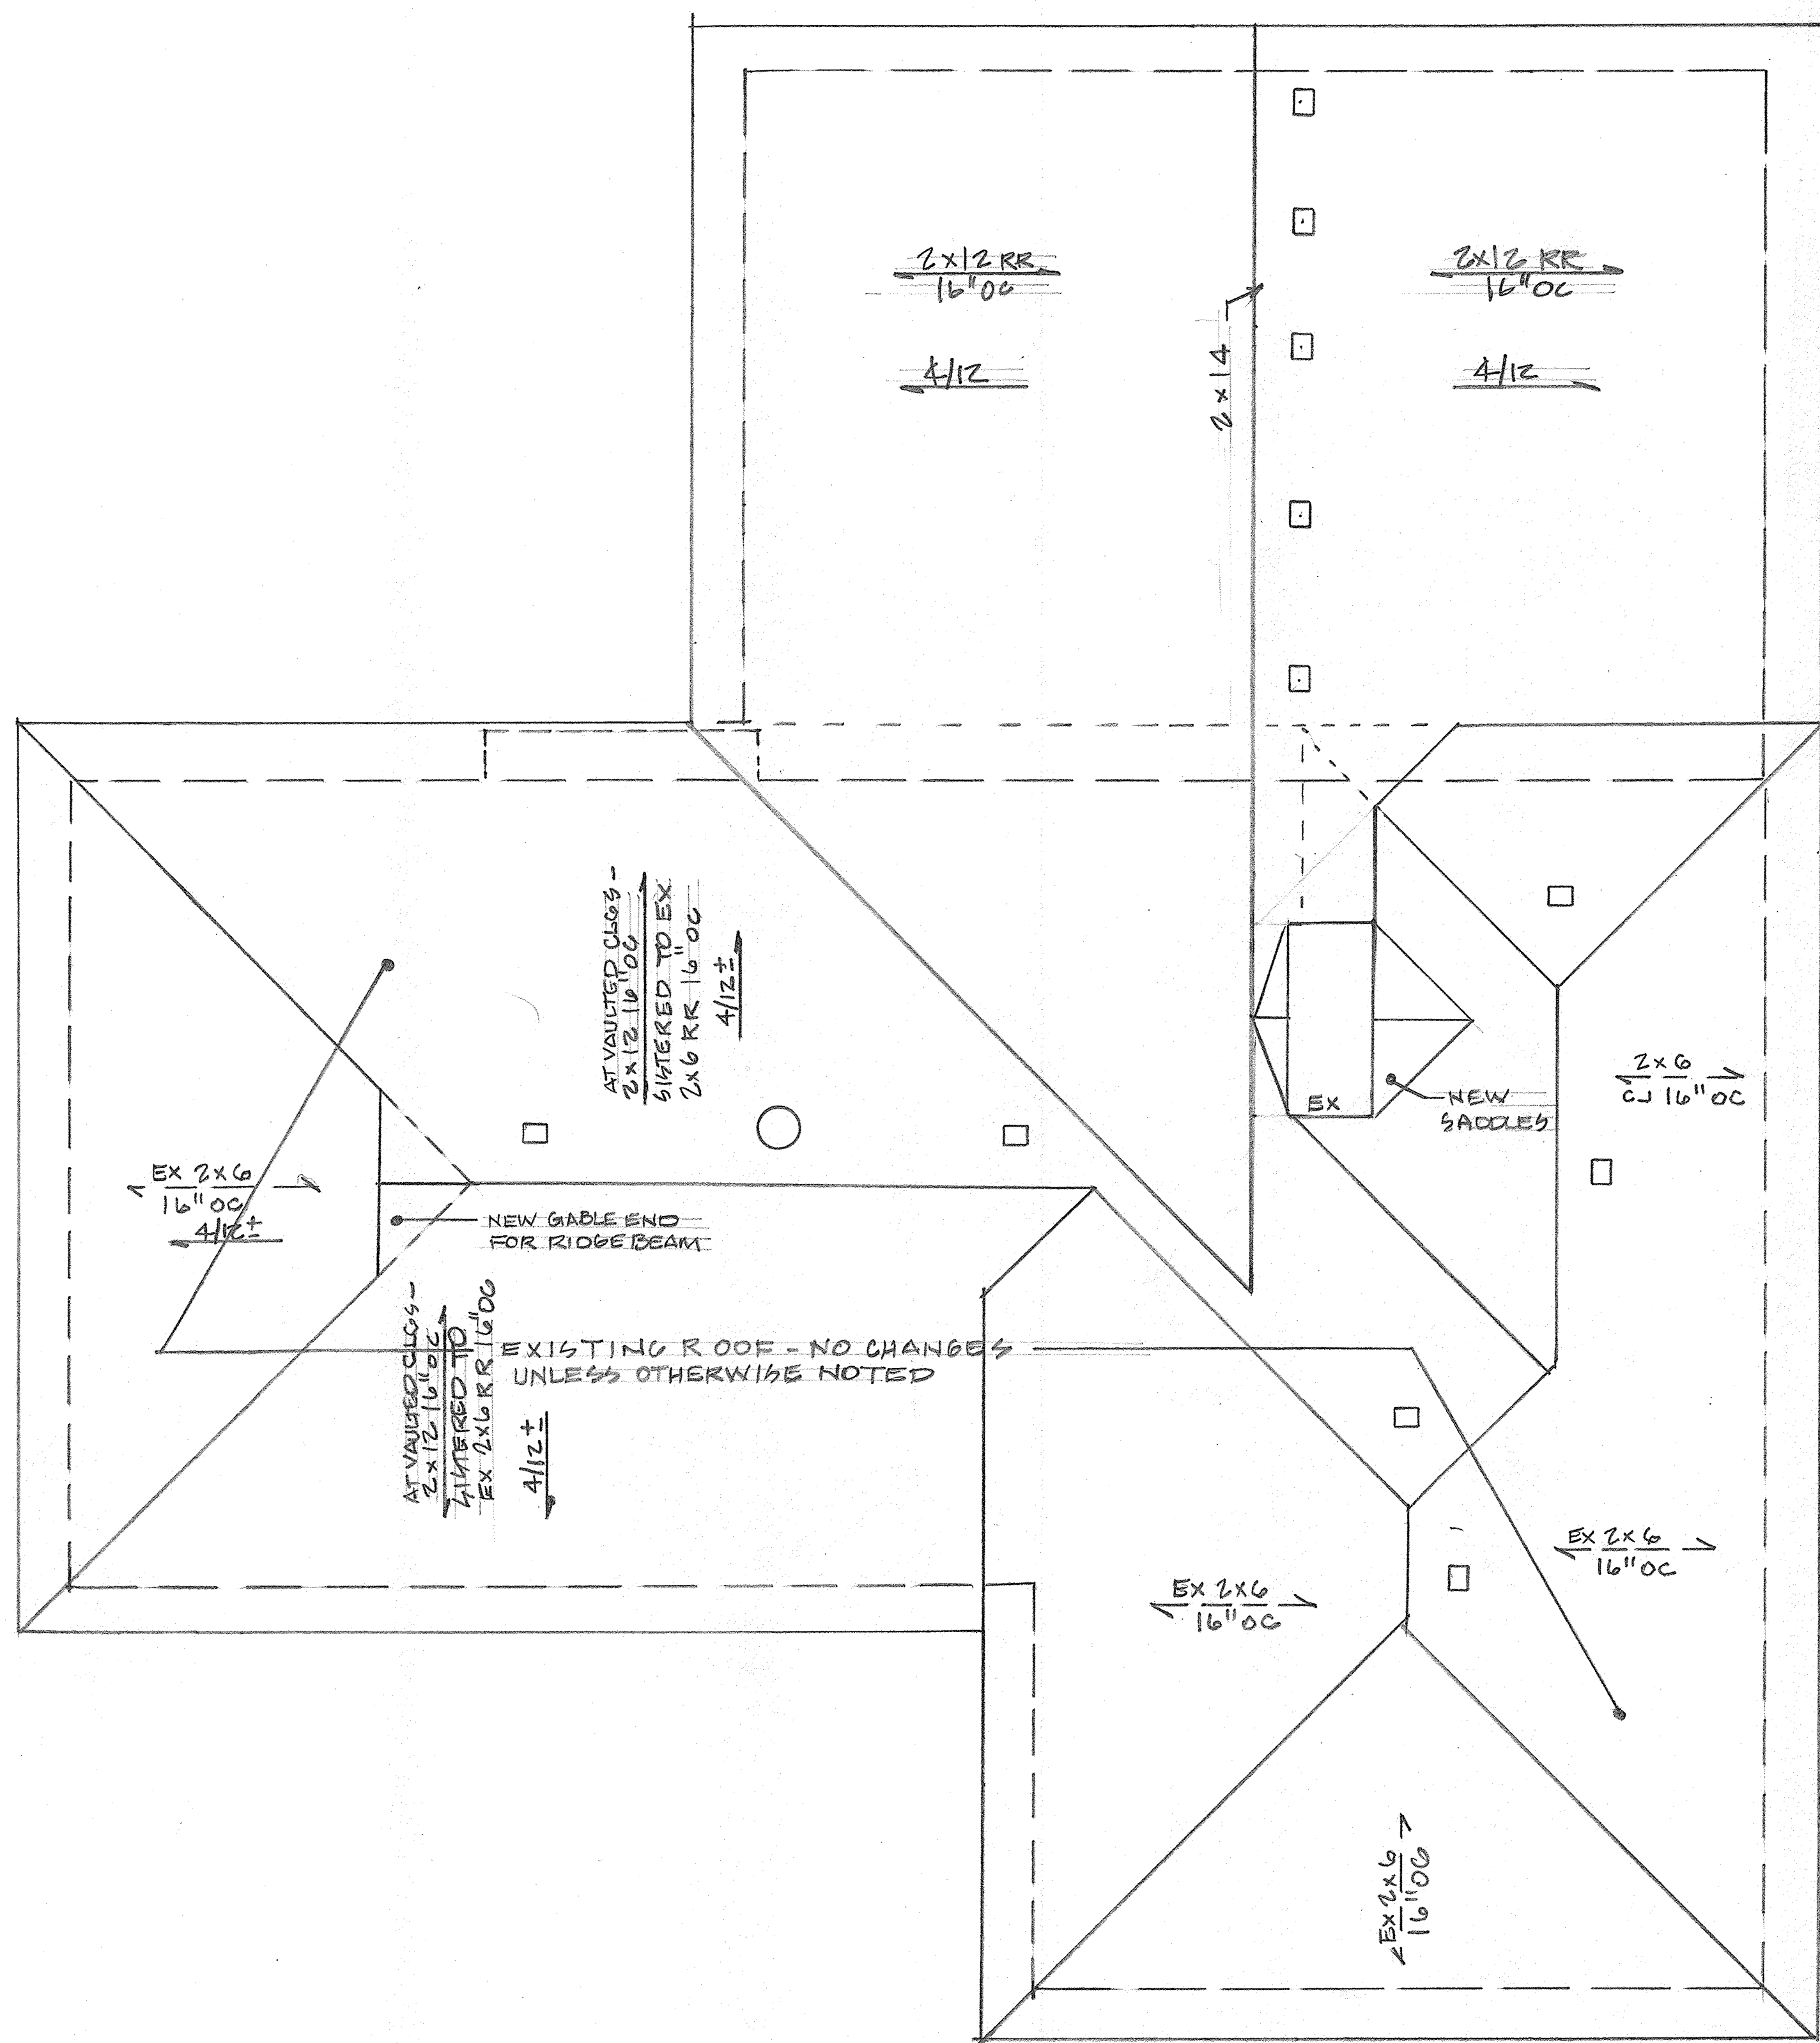

- Electrical Symbols**
- ⊙ SP 110v smoke detector with battery back-up
  - ⊙ CO c.o. detector
  - ⊕ surface mounted incandescent ceiling fixture
  - ⊕ wall mounted incandescent light fixture
  - ⊕ R recessed incandescent light fixture
  - ⊕ ceiling mounted light fixture with exhaust fan
  - ⊕ ceiling mounted fluorescent light fixture
  - ⊕ wall mounted duplex outlet
  - ⊕ GFI wall mounted ground fault protected outlet
  - ⊕ WFI exterior waterproof outlet
  - ⊕ ARC arc fault protected wall mounted duplex outlet

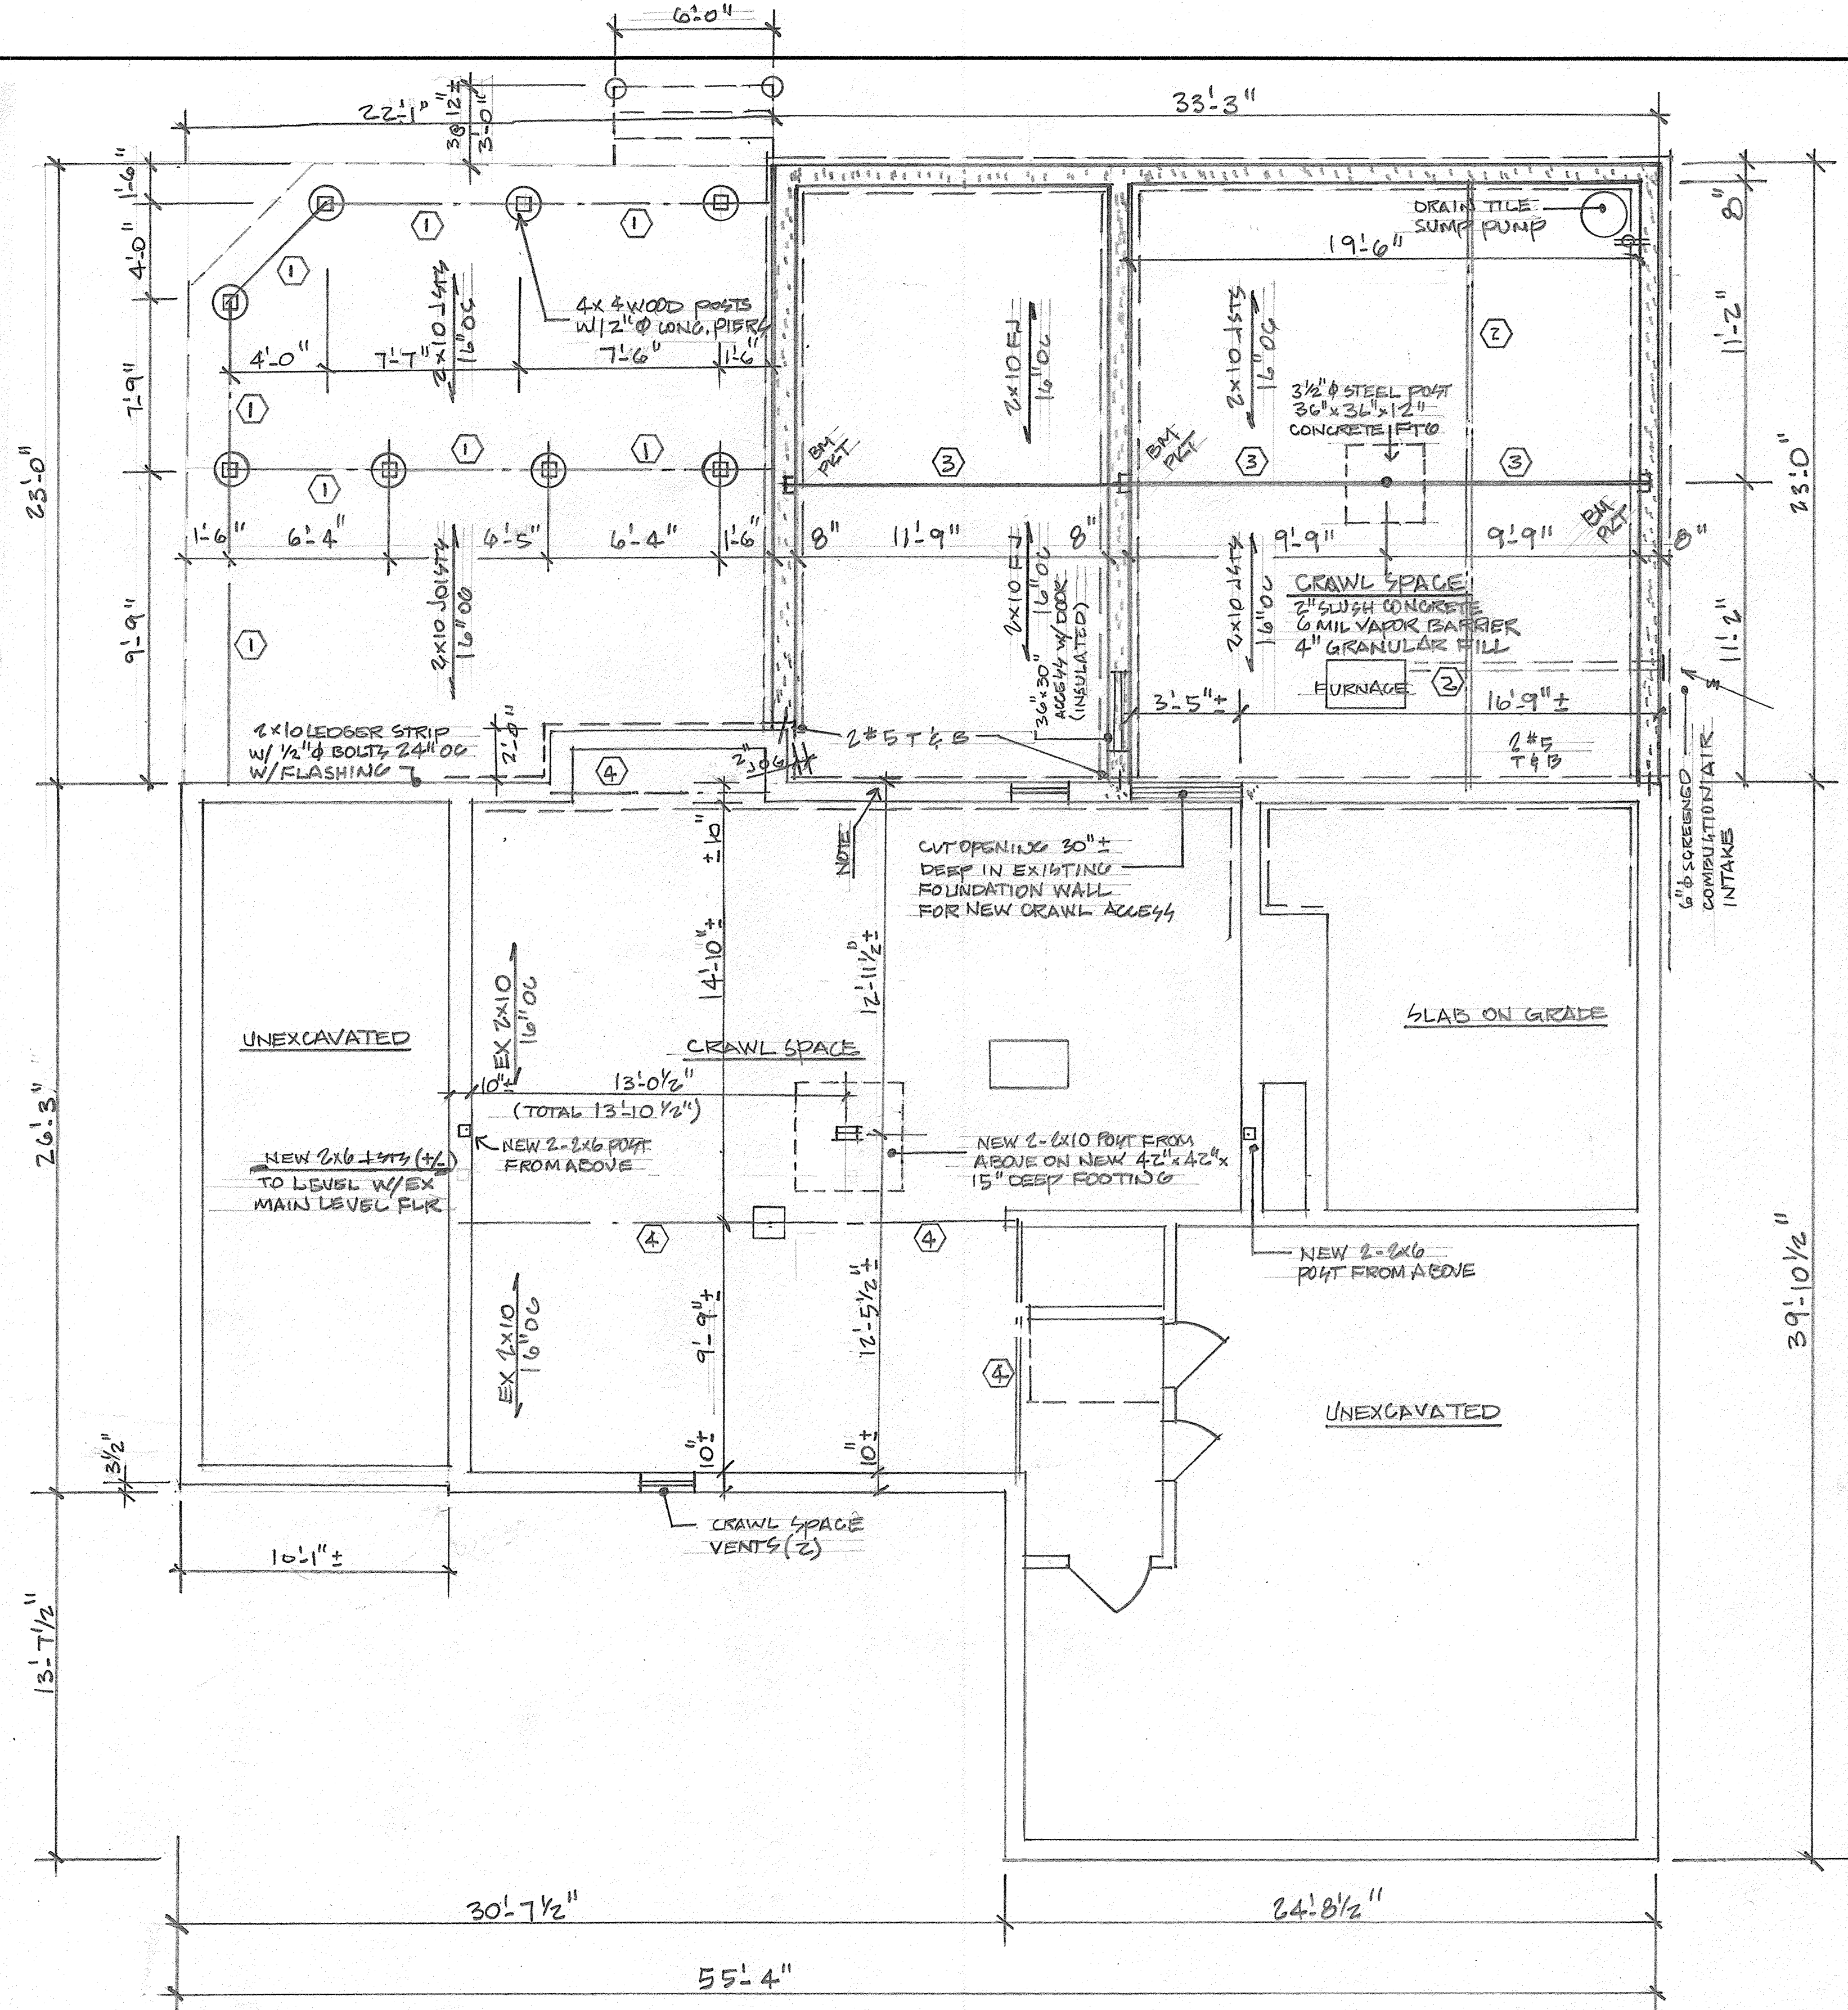

**ROOF PLAN** 1/8" = 1'-0"

4/12 ARROW INDICATES DIRECTION OF FLOW OF RAINWATER. NUMBERS INDICATE ROOF PITCH OF THAT SURFACE. (4/12 = 4" RISE 12" RUN)

FRAMING SPAN ARROW INDICATES DIRECTION OF SPAN AND SIZE + SPACING OF FRAMING MEMBERS. (ALL ROOF RAFTERS TO BE HEM-FIR #2)

⊕ INDICATES METAL ROOF VENT LOCATION. METAL ROOF VENTS ARE 12"x12" ± ALLOW .50" OF VENT AREA


**NUMBER OF ROOF VENTS REQ'D. (1/300# OF ROOF AREA)**

ROOF AREA = 752  
 VENT AREA REQ'D. = 2.41  
 # OF 12"x12" VENTS REQ'D. = 4.8  
 ACTUAL # OF VENTS = 5 PLUS 4 OFFSET VENTS

**HEADER SCHEDULE**

①	2	2x10
②	2	1 3/4" x 9 1/4" LVL
③	1	W 8 x 18 STEEL BEAM
④		EXISTING - NO CHANGE
⑤		
⑥		
⑦		

**FOUNDATION PLAN** 1/4" = 1'-0"

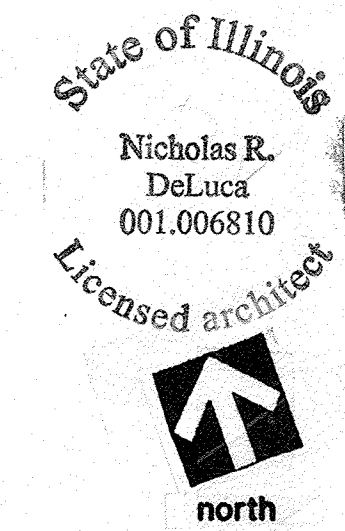

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<b>REMODEL &amp; ADDITION</b> <b>SUE &amp; BOB BOLES</b> 25 FULTON STREET GENEVA, IL.	
project number: 202026	prepared by: ND
date: 8/28/20	sheet number: 5 OF 10
<input type="checkbox"/> NEW FOUNDATION PLAN <input checked="" type="checkbox"/> ROOF PLAN	





ROOM FINISH SCHEDULE					
USE OF SPACE	FLOORING	BASE	WALLS	CEILING	REMARKS
FOYER	HARDWOOD	WOOD	DRYWALL	DRYWALL	VAULTED CEILING
LIVING					" " "
OFFICE					FLAT CEILING
KITCHEN					VAULTED CEILING PARTIAL FLAT CEILING
FAMILY RM					" " "
PANTRY					FLAT CEILING
LAUNDRY	CERAMIC TILE				" " "
BEDROOM #1	HARDWOOD	WOOD	DRYWALL	DRYWALL	VAULTED CEILING
BATH #1	CERAMIC TILE				FLAT CEILING
CLOSET	HARDWOOD				" " "
CLOSET #	SAME AS ADJOINING SPACE (UNLESS NOTED)				
MUD ROOM	EX CONCRETE	EX	EX	EX	FLAT CEILING
SCREENED PORCH	CEDAR WOOD	WOOD	SMARTSIDE SIDING	SMARTSIDE SIDING	VAULTED CEILING

WINDOW SCHEDULE				
MARK	GLASS SIZE	VENT AREA	CLEAR OPENING	REMARKS
1	24/60(2) CASE	11.2	26/62	
2	24/60(1) CASE	11.2	26/62	
3	42/10/32(1) CASE	3.5	12/42	VERIFY WIDTH-VERIFY DEEP TO PROVIDE 4" BACKSPASH
4	42/26/32(3) CASE	8.19(1)	28/42	SAME AS ABOVE
5	24/60(2) CASE	11.2	26/62	
6	42/18(1) TR.	6.11	44/20	
7	24/40(2) CASE	11.2	26/62	
8	42/18(1) TR.	6.11	44/20	TEMPERED GLASS
9	20/36(1) CASE	6.64	22/38	
10	24/60(1) CASE	11.2	26/62	

DOOR SCHEDULE					
MARK	SIZE	DESCRIPTION	DOOR MAT'L	FRAME	REMARKS
1	3'-6" x 6'-8" x 1 3/4"	ENTRY	WOOD	WOOD	
2	16'-0" x 6'-0" x	GARAGE	" "	" "	NEW OVERHEAD DOOR VERIFY SIZE
3	3'-0" x 6'-8" x 1 3/4"	PORCH	WOOD/SCREEN	" "	
4	3'-0" x 6'-8" x 1 3/4"	GARAGE/MUD	SOLID WOOD	" "	1 3/4" SOLID CORE "B" LABEL (EXIST'G)
5	EXISTING - NO CHANGES				
6	3'-0" x 6'-8" x 1 3/4"	CLOSET	WOOD	WOOD	
7	3'-0" x 6'-8" x 1 3/4"	PANTRY	" "	" "	SLIDING "BARN" DOOR SAME AS ABOVE
8	2'-4" x 6'-8" x 1 3/4"	BATHROOM #1	" "	" "	
9	2'-4" x 6'-8" x 1 3/4"	CLOSET	" "	" "	
10	2'-4" x 6'-8" x 1 3/4"	TOILET ROOM	" "	" "	POCKET DOOR
11	2'-6" x 6'-8" x 1 3/4"	BEDROOM #1	" "	" "	
12	3'-0" x 6'-8" x 1 3/4"	BEDROOM #1	WOOD GLASS	" "	FRENCH DOOR- TEMPERED GLASS SLIDING DOOR TEMPERED GLASS
13	10'-0" x 6'-8" x 1 3/4"	FAMILY ROOM	" "	" "	

VENTILATION SCHEDULE						
ROOM	FLOOR AREA	LIGHT		VENT		REMARKS
		REQ'D	ACTUAL	REQ'D	ACTUAL	
FAMILY/LIVING/OFFICE/KITCHEN	4621	49.6	72.5	25.0	38.3	
BEDROOM #1	208	16.6	52.7	8.3	26.3	
BATHROOM #1	96	7.6	6.11	3.8	6.11	125 CFM MECH. EXHAUST
BEDROOM #2	117	9.3	24.8	4.7	12.3	
BEDROOM #3	175	14.0	24.3	7.0	12.3	
BEDROOM #4	150	12.0	26.4	6.0	13.2	
BATHROOM #2	30	-	6.7	-	3.36	100 CFM MECH. EXHAUST
BATHROOM #3	25	-	6.11	-	6.11	" " " "

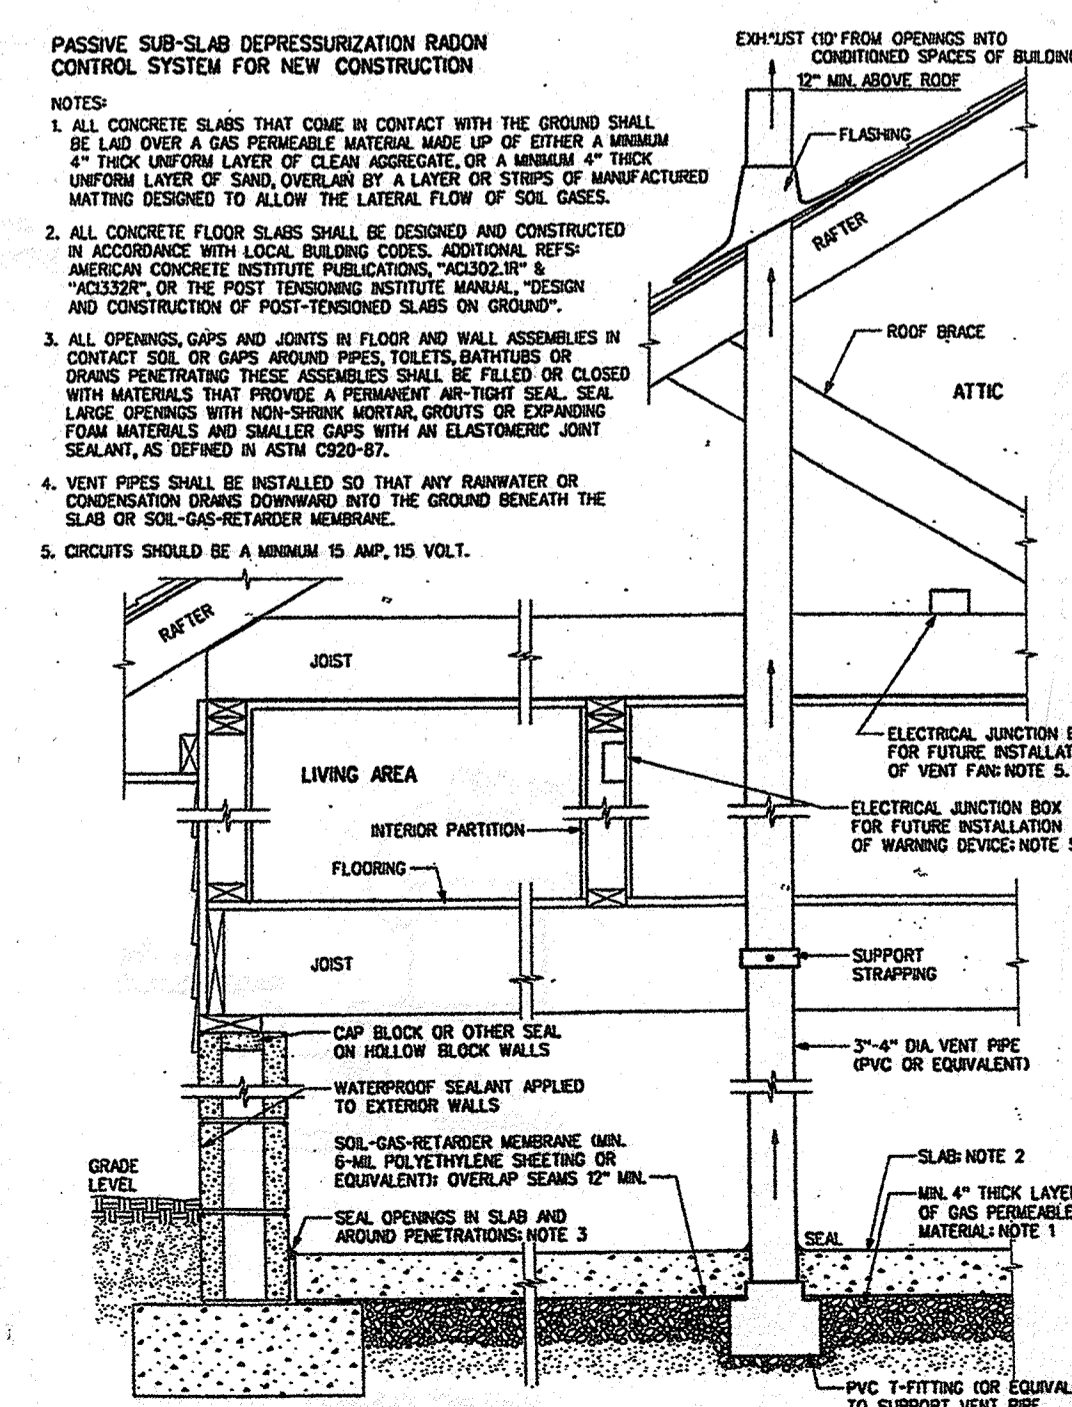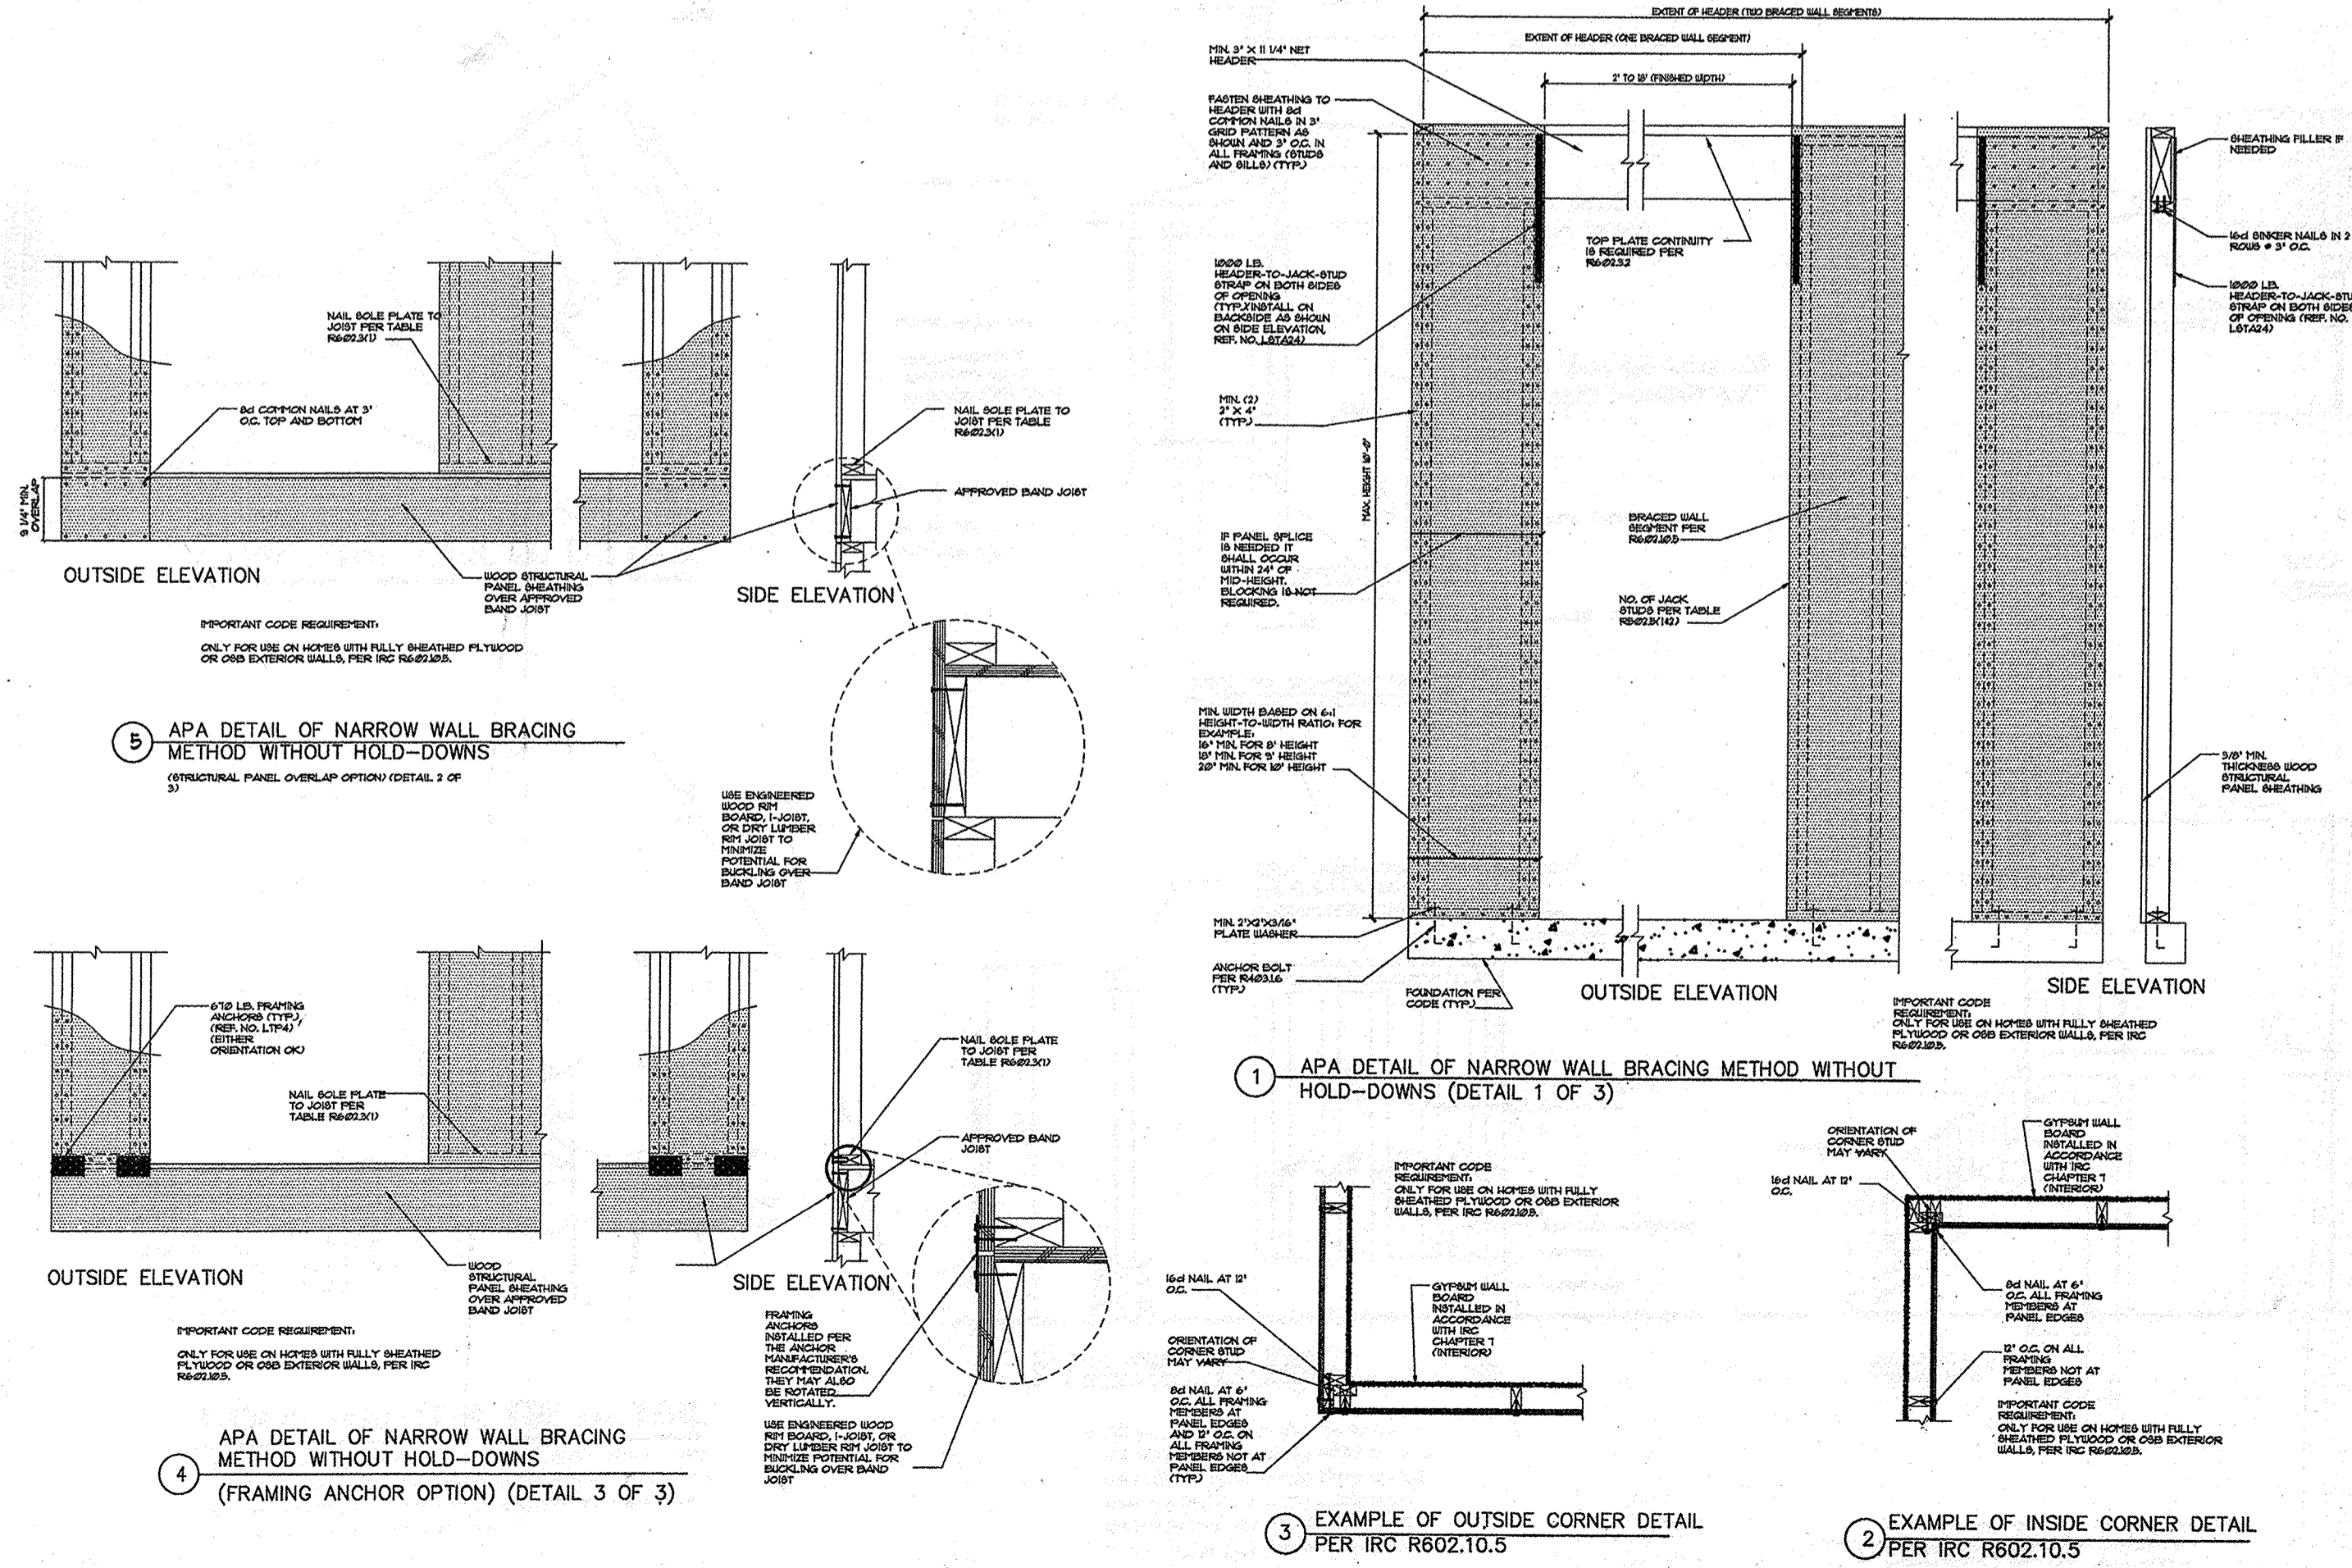

USE	LIVE LOAD
Attics with limited storage	20
Attics without storage	10
Decks	40
Exterior balconies	60
Fire escapes	40
Guardrails and handrails	200
Guardrails in-fill components	50
Passenger vehicle garages	50*
Rooms other than sleeping rooms	40
Sleeping rooms	30
Stairs	40*

MIN. UNIFORMLY DISTRIBUTED LIVE LOADS  
(IN POUNDS PER SQUARE FOOT)

Panel Layout 200 Amp, 40 Space					
No. Amp.			Amp. No.		
1	15	Bedroom	Kitchen Outlet	20	2
3	15	Bedroom	Kitchen Outlet	20	4
5	15	Bedroom	Refrigerator	15	6
7	15	Bedroom	Microwave	15	8
9	20	Bath/Powder GFCI	Master Bath GFCI	20	10
11	15	Bath/Powder lighting	Master Bath Lighting	15	12
13	15	Living Room	Whirlpool GFCI	15	14
15	20	Dining Room	Living Room	15	16
17	20	Breakfast	Oven	18	18
19	15	Kitchen Lighting	Oven	50	20
21	15	Dishwasher / Disposal	AC	22	22
23	15	Garage	AC	40	24
25	15	Foyer / Hall Lighting	Laundry	20	26
27	15	Basement	Furnace	15	28
29	15	Smoke Detectors	Sump Pump	15	30
31	15	Den	Ejector Pump	15	32
33					34
35					36
37					38
39					40

ELECTRIC PANEL SCHEDULE  
MAINTAIN 10% FREE FOR FUTURE EXPANSION




GENERAL NOTES: NEW CONSTRUCTION

- ALL CONSTRUCTION TO BE IN ACCORDANCE WITH THE LOCAL BUILDING ORDINANCES, AMENDMENTS AND ZONING ORDINANCE.
- ALL CONSTRUCTION TO BE DONE IN A WORKMANLIKE MANNER AND WHEN NOT SPECIFICALLY DESCRIBED OR REGULATED BY VILLAGE ORDINANCES OR SHOWN ON DRAWINGS, SHALL BE PERFORMED TO ACCEPTABLE STANDARD PRACTICE.
- ALL PLUMBING, ELECTRICAL AND MECHANICAL WORK TO BE COMPLETE AND IN ACCORDANCE WITH ALL APPLICABLE CODES AND ORDINANCES.
- DO NOT SCALE DRAWINGS. USE DIMENSIONS SHOWN.
- ALL CONTRACTORS TO VISIT SITE AND FAMILIARIZE THEMSELVES WITH ALL EXISTING JOB SITE CONDITIONS.
- NOTIFY ARCHITECT, IN WRITING, OF ANY AND ALL DISCREPANCIES BEFORE PROCEEDING WITH WORK OF ANY NATURE.
- ALL CONCRETE SHALL HAVE A MINIMUM STRENGTH OF 3000 PSI AT 28 DAYS. IT SHALL BE ASSUMED FOR THIS DESIGN THAT A 2500 PSF MINIMUM SOIL BEARING CAPACITY IS PRESENT. IF NOT, THE ARCHITECT SHALL BE NOTIFIED IMMEDIATELY.
- ALL FOOTINGS SHALL BEAR ON UNDISTURBED VIRGIN SOIL.
- ALL FLOOR JOISTS DESIGNED AT 40# LIVE LOAD, 10# DEAD LOAD. CEILING JOISTS DESIGNED AT 20# LIVE LOAD, 10# DEAD LOAD. ROOF RAFTERS DESIGNED AT 30# LIVE LOAD, 10# DEAD LOAD.
- ALL STRUCTURAL LUMBER FOR FLOOR JOISTS, CEILING JOISTS, ROOF RAFTERS, HEADERS AND BEAMS TO BE WESTERN WOOD PRODUCTS, HEM-FIR #2 UNLESS NOTED OTHERWISE.
- FIRE-STOPPING AND DRAFT-STOPPING SHALL BE INSTALLED AS SPECIFIED BY BUILDING CODE.
- PROVIDE DOUBLE JOISTS UNDER ALL PARALLEL PARTITIONS (TYPICAL FOR ALL FLOORS). PROVIDE BRIDGING AS REQUIRED.
- ALL INTERIOR AND EXTERIOR DOOR AND WINDOW HEADERS SHALL BE 2 - 2 x 12 UNLESS NOTED OTHERWISE.
- ALL PLUMBING WALLS TO BE 2 x 6 WOOD STUDS.
- ALL WALLS OVER 10'-0" TALL TO BE 2 x 6 WOOD STUDS.
- ALL STAIRS MAXIMUM 7/8" RISE, MINIMUM TREAD 10" CLEAR OF TREAD ABOVE, MINIMUM 36" WIDE, CONTINUOUS CLEAR VERTICAL HEADROOM FROM FRONT NOSING OF TREAD TO A LINE PARALLEL WITH STAIR RUN OF 6'-8".
- DOUBLE ALL JOISTS UNDER BATHTUBS.
- ALL WINDOW GLAZING TO BE AS SPECIFIED BY BUILDING CODE.
- ALL PLUMBING (SINKS, TOILETS, SHOWERS, TUBS, ETC.) TO BE INSTALLED IN ACCORDANCE WITH ALL APPLICABLE SECTIONS OF THE BUILDING CODE.
- ALL ELECTRIC TO BE INSTALLED IN ACCORDANCE WITH ALL APPLICABLE SECTIONS OF THE 2014 N.E.C. CODE.
- ALL 125V, 14, 15 AND 20 AMP RECEPTACLES, ELECTRICAL EQUIPMENT, LIGHT FIXTURES, AND FANS, INSTALLED IN BATHROOMS SHALL HAVE G.F.C.I. PROTECTION.
- ALL 125V, 14, 15 AND 20 AMP RECEPTACLES INSTALLED BELOW GRADE SHALL HAVE G.F.C.I. PROTECTION.

State of Illinois  
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DeLuca  
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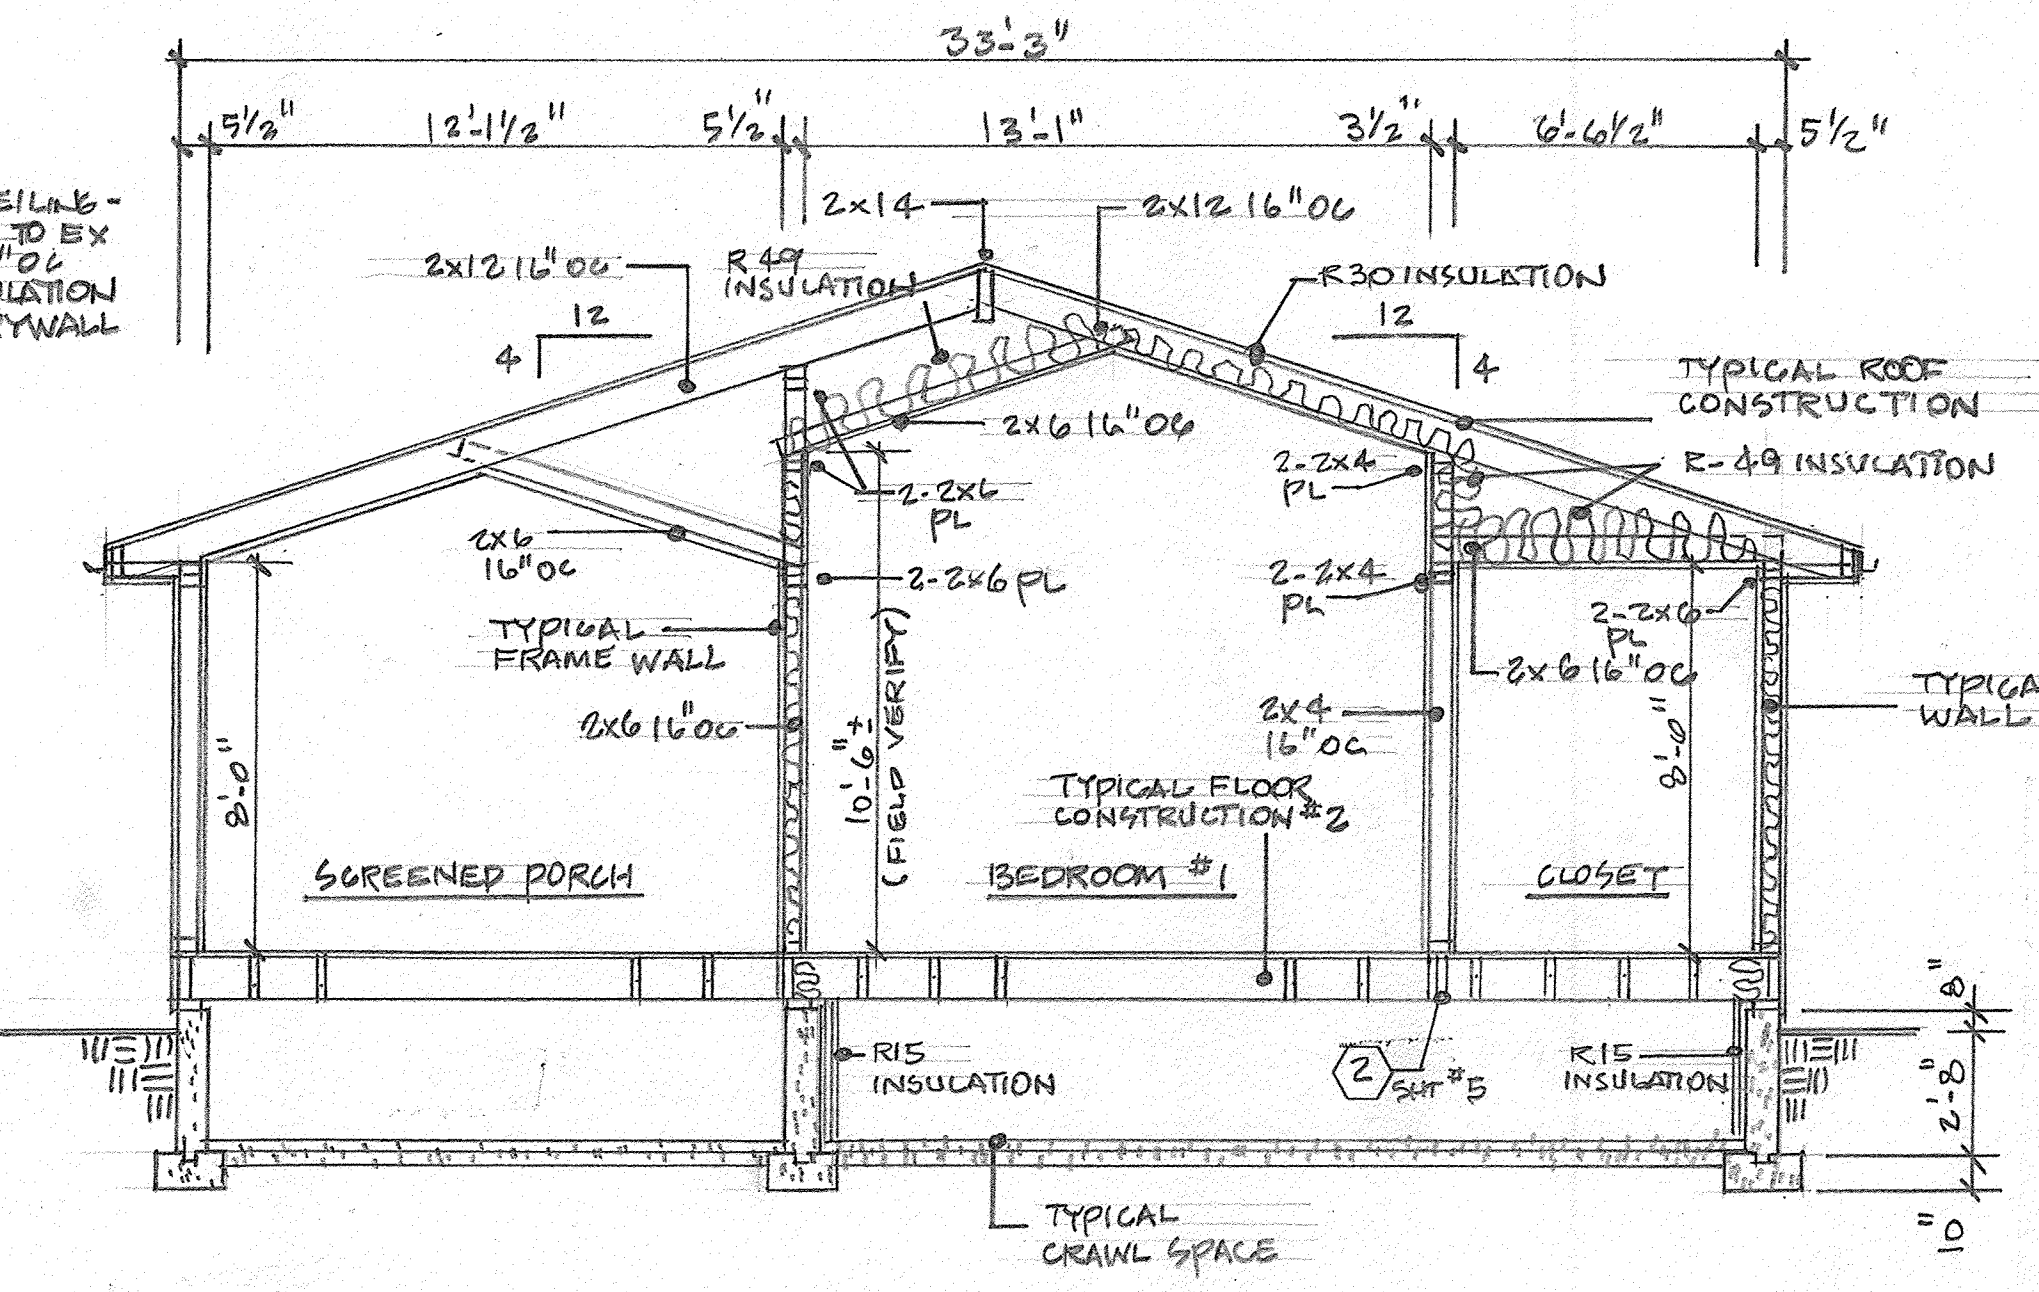
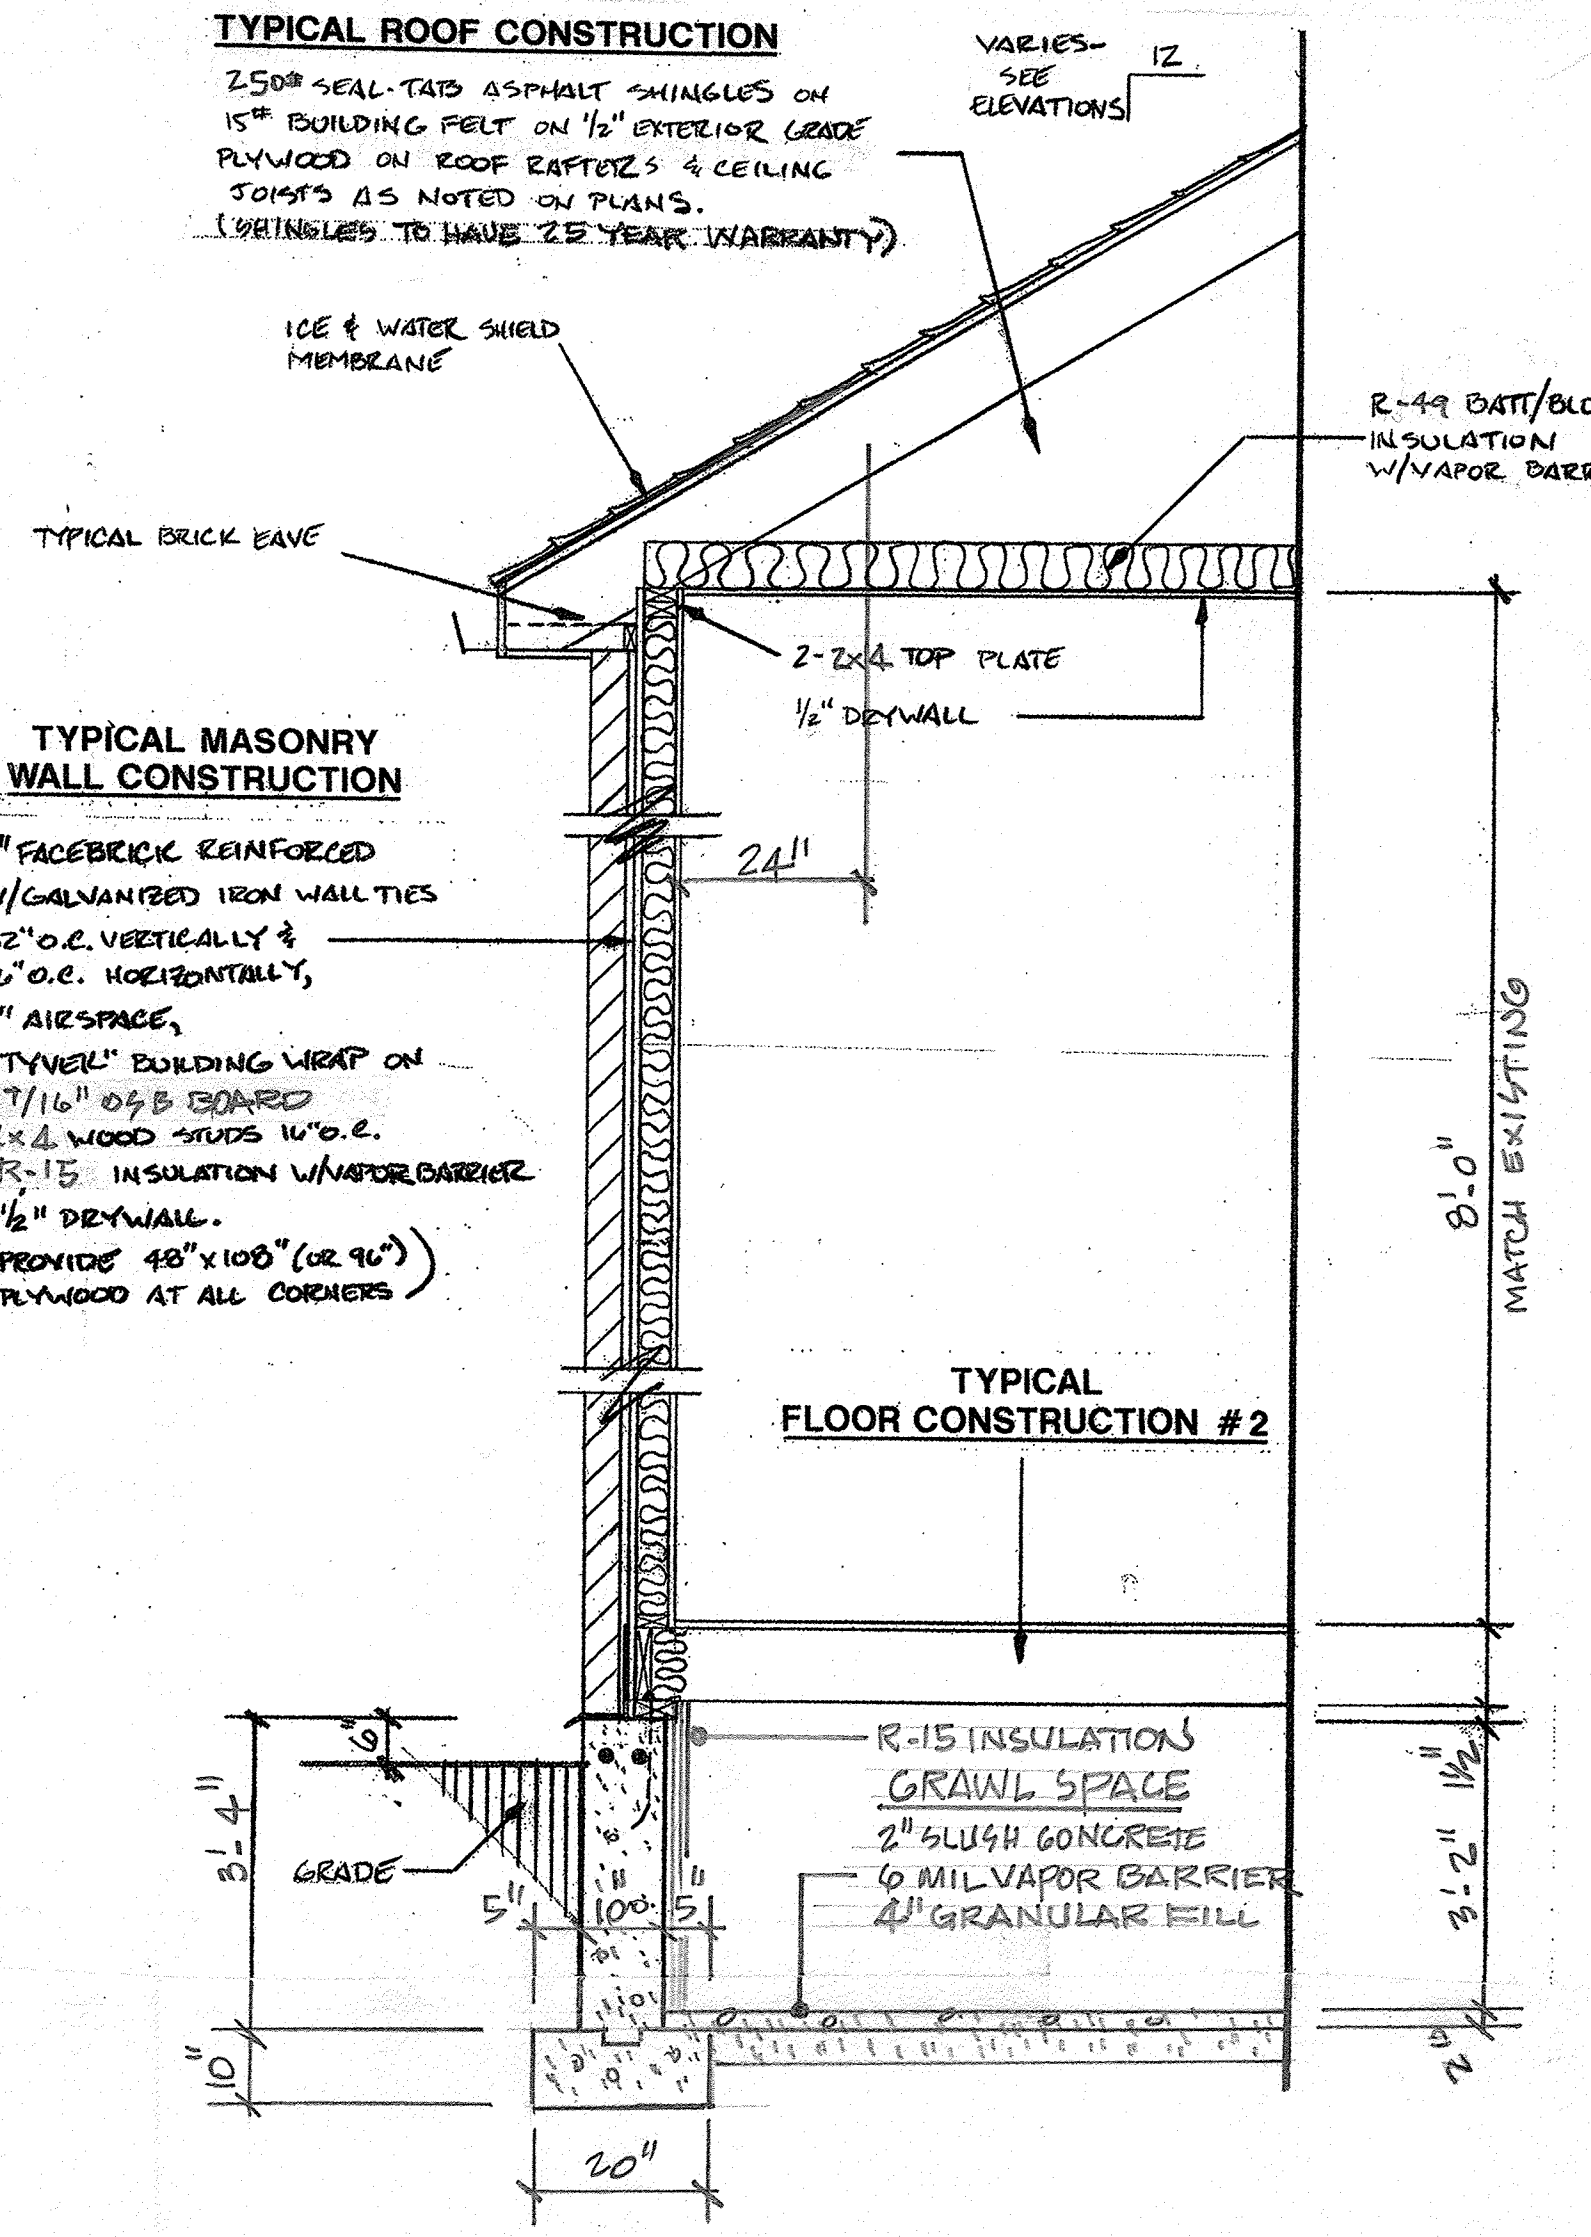
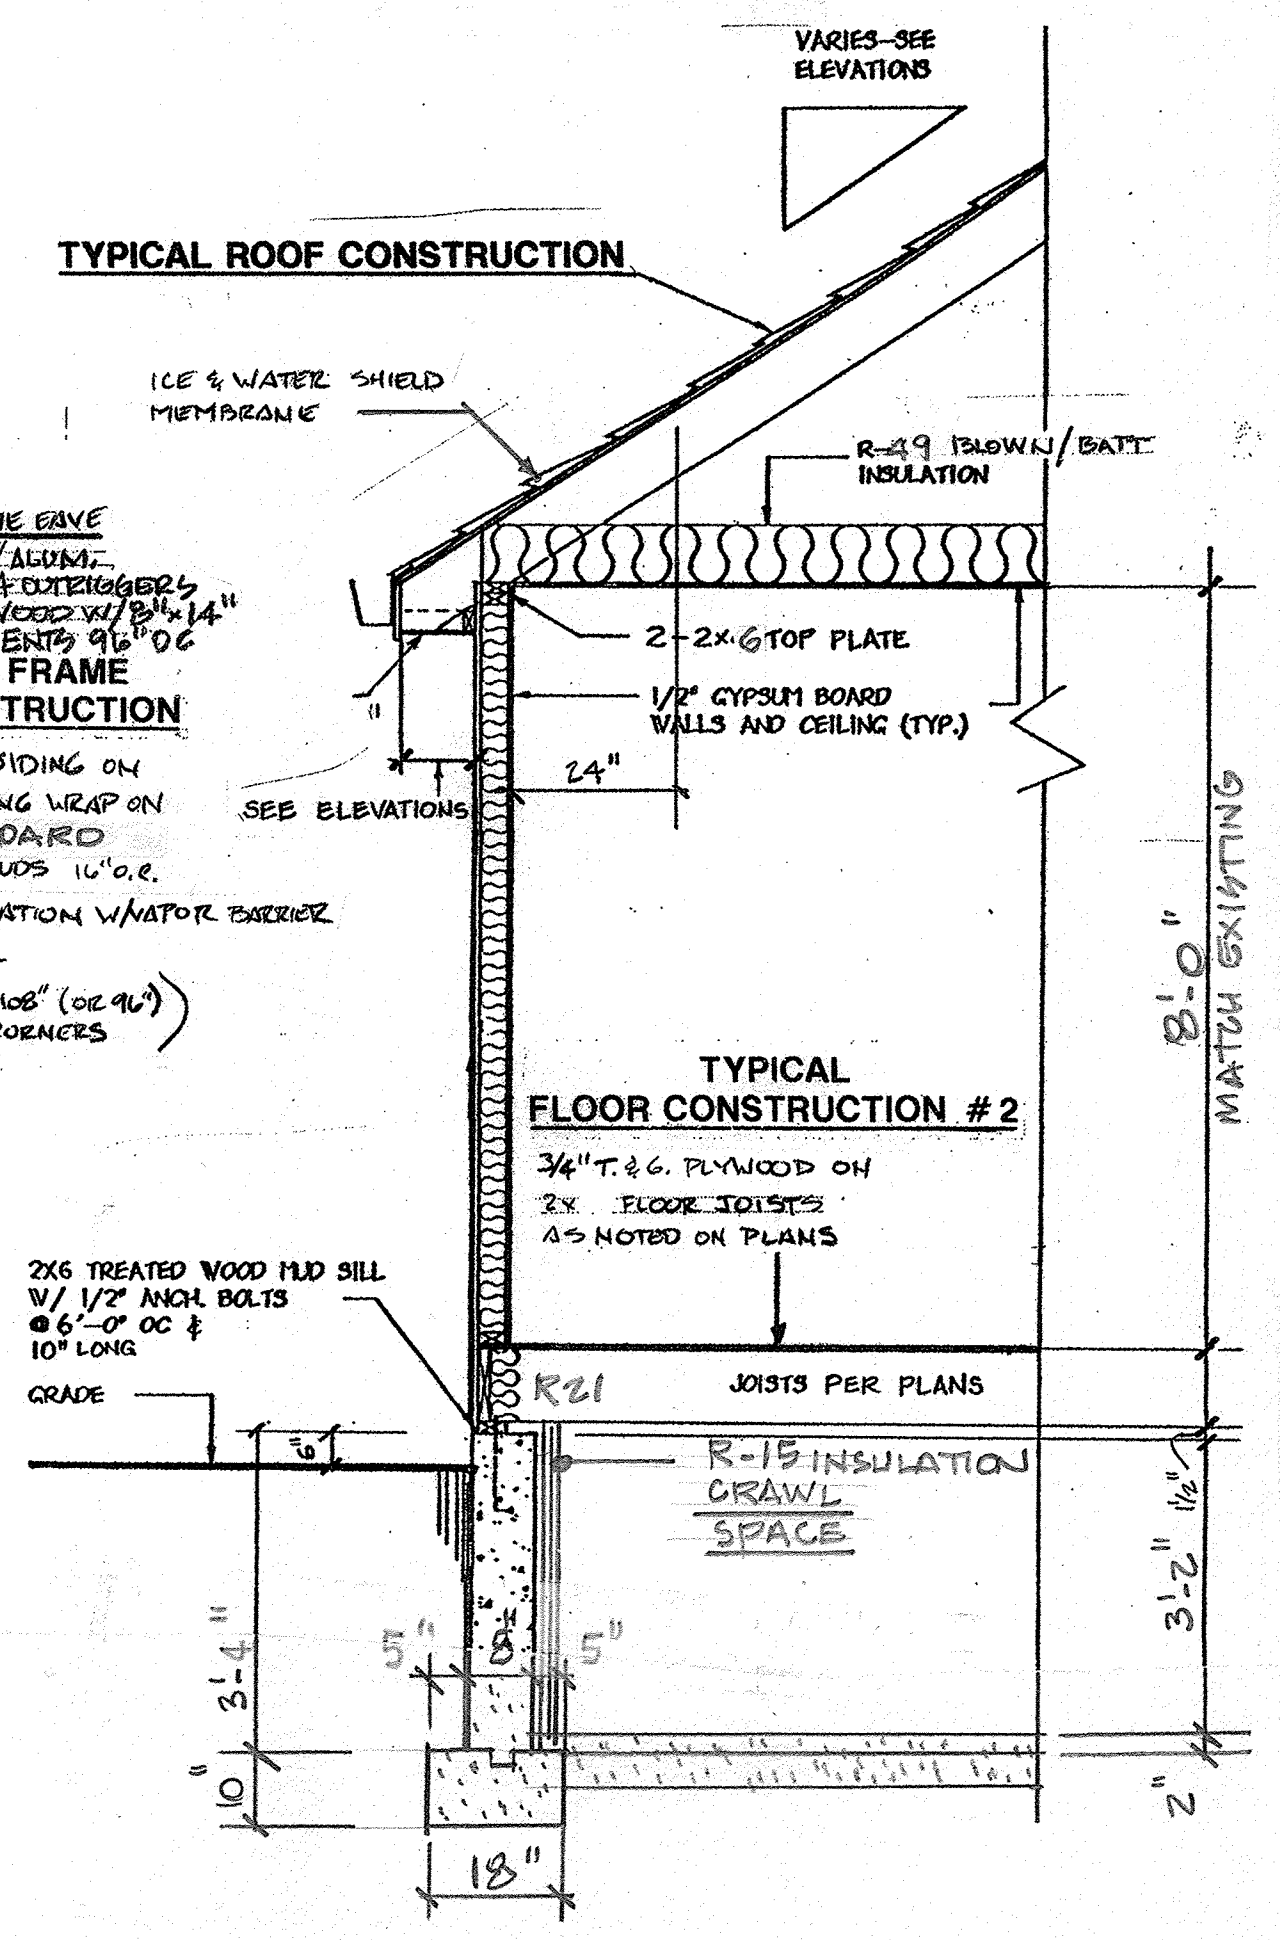
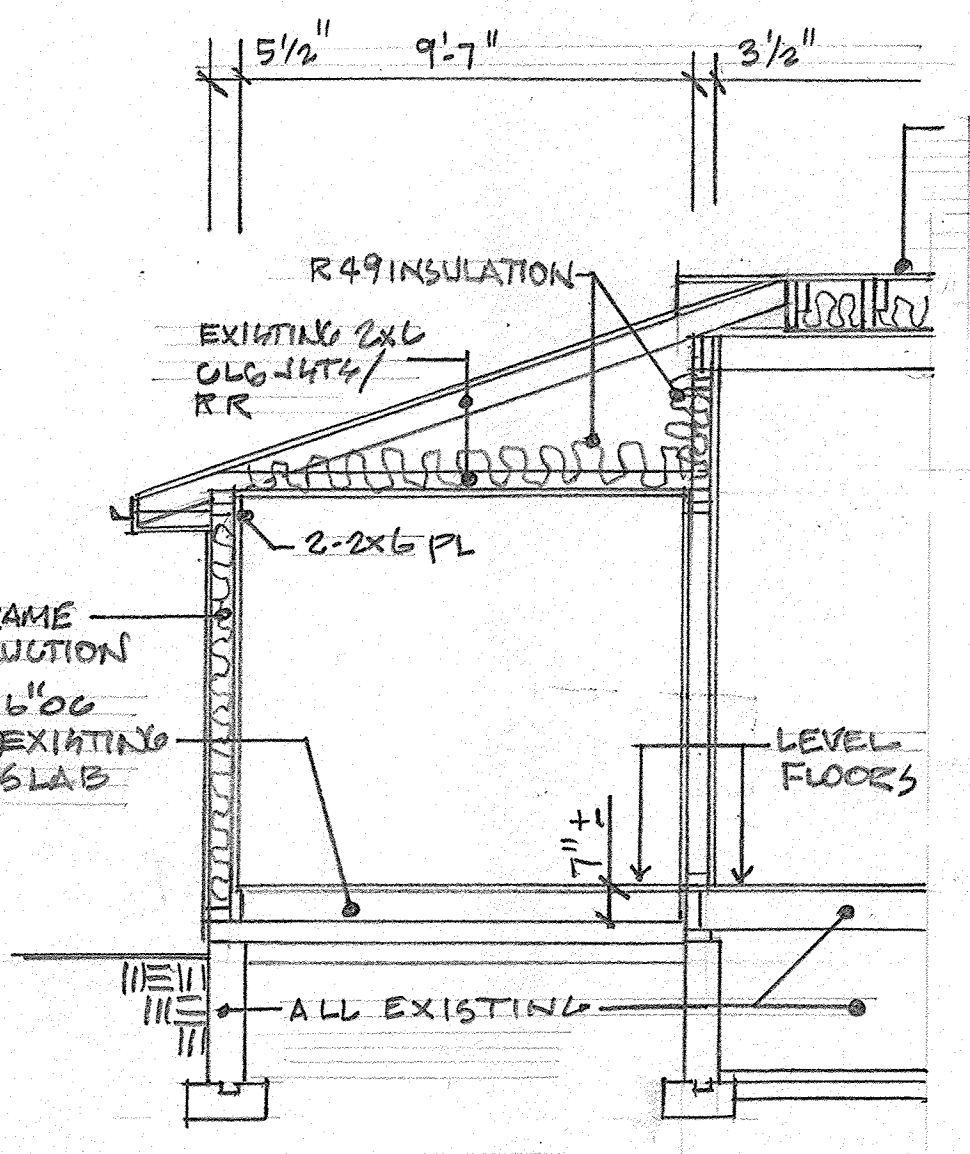
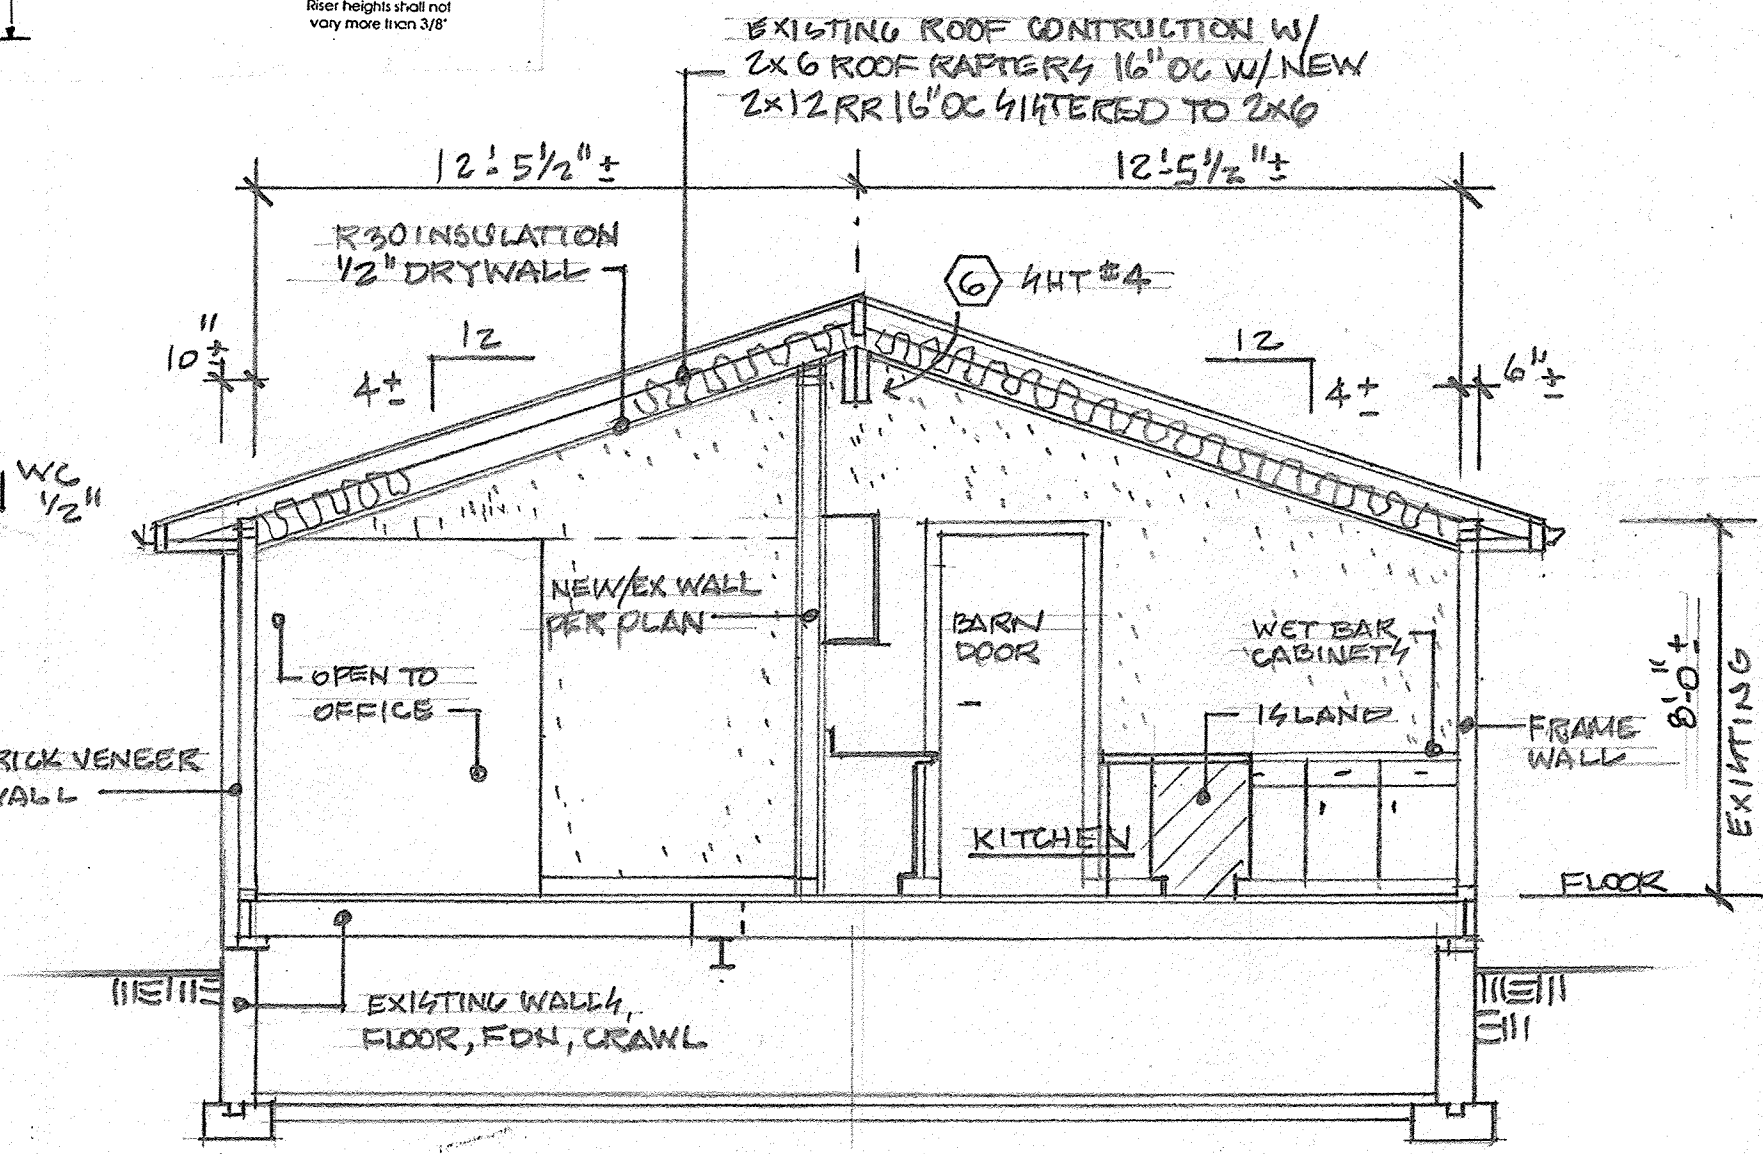
Issued for permit:	Issued for construction:
<b>ND</b> Nicholas R. DeLuca 1807 West Ditch Road, Suite 200 Naperville, IL 60563	architect (630) 637-8213
REMODEL & ADDITION <b>SUE &amp; BOB ROLES</b>	
25 FULTON STREET GENEVA, IL.	project number: 202026 prepared by: ND date: 8/28/20 sheet number: 6 OF 10
<ul style="list-style-type: none"> <li>SCHEDULE - DOOR, ROOM FINISH, WINDOW, VENT</li> <li>WALL BRACING DETAILS</li> <li>RADON DIAGRAM</li> <li>GENERAL NOTES</li> </ul>	



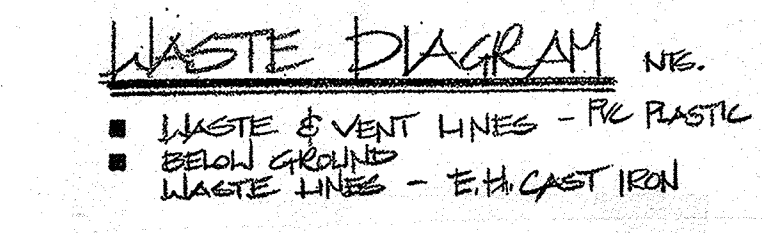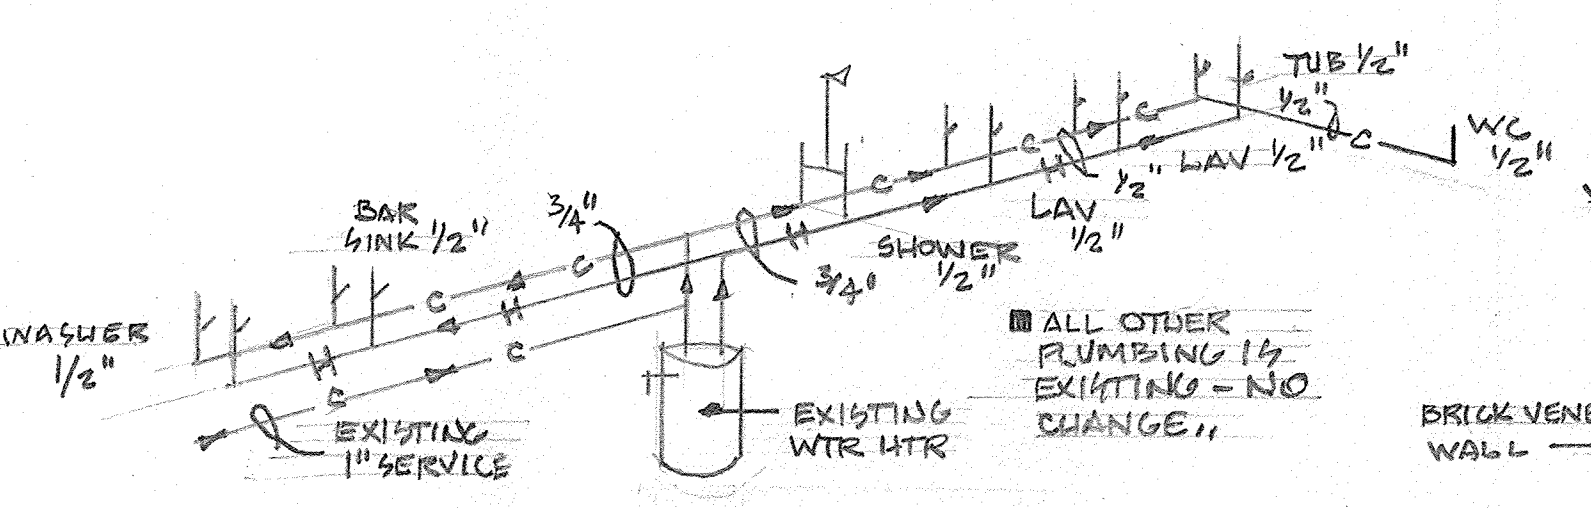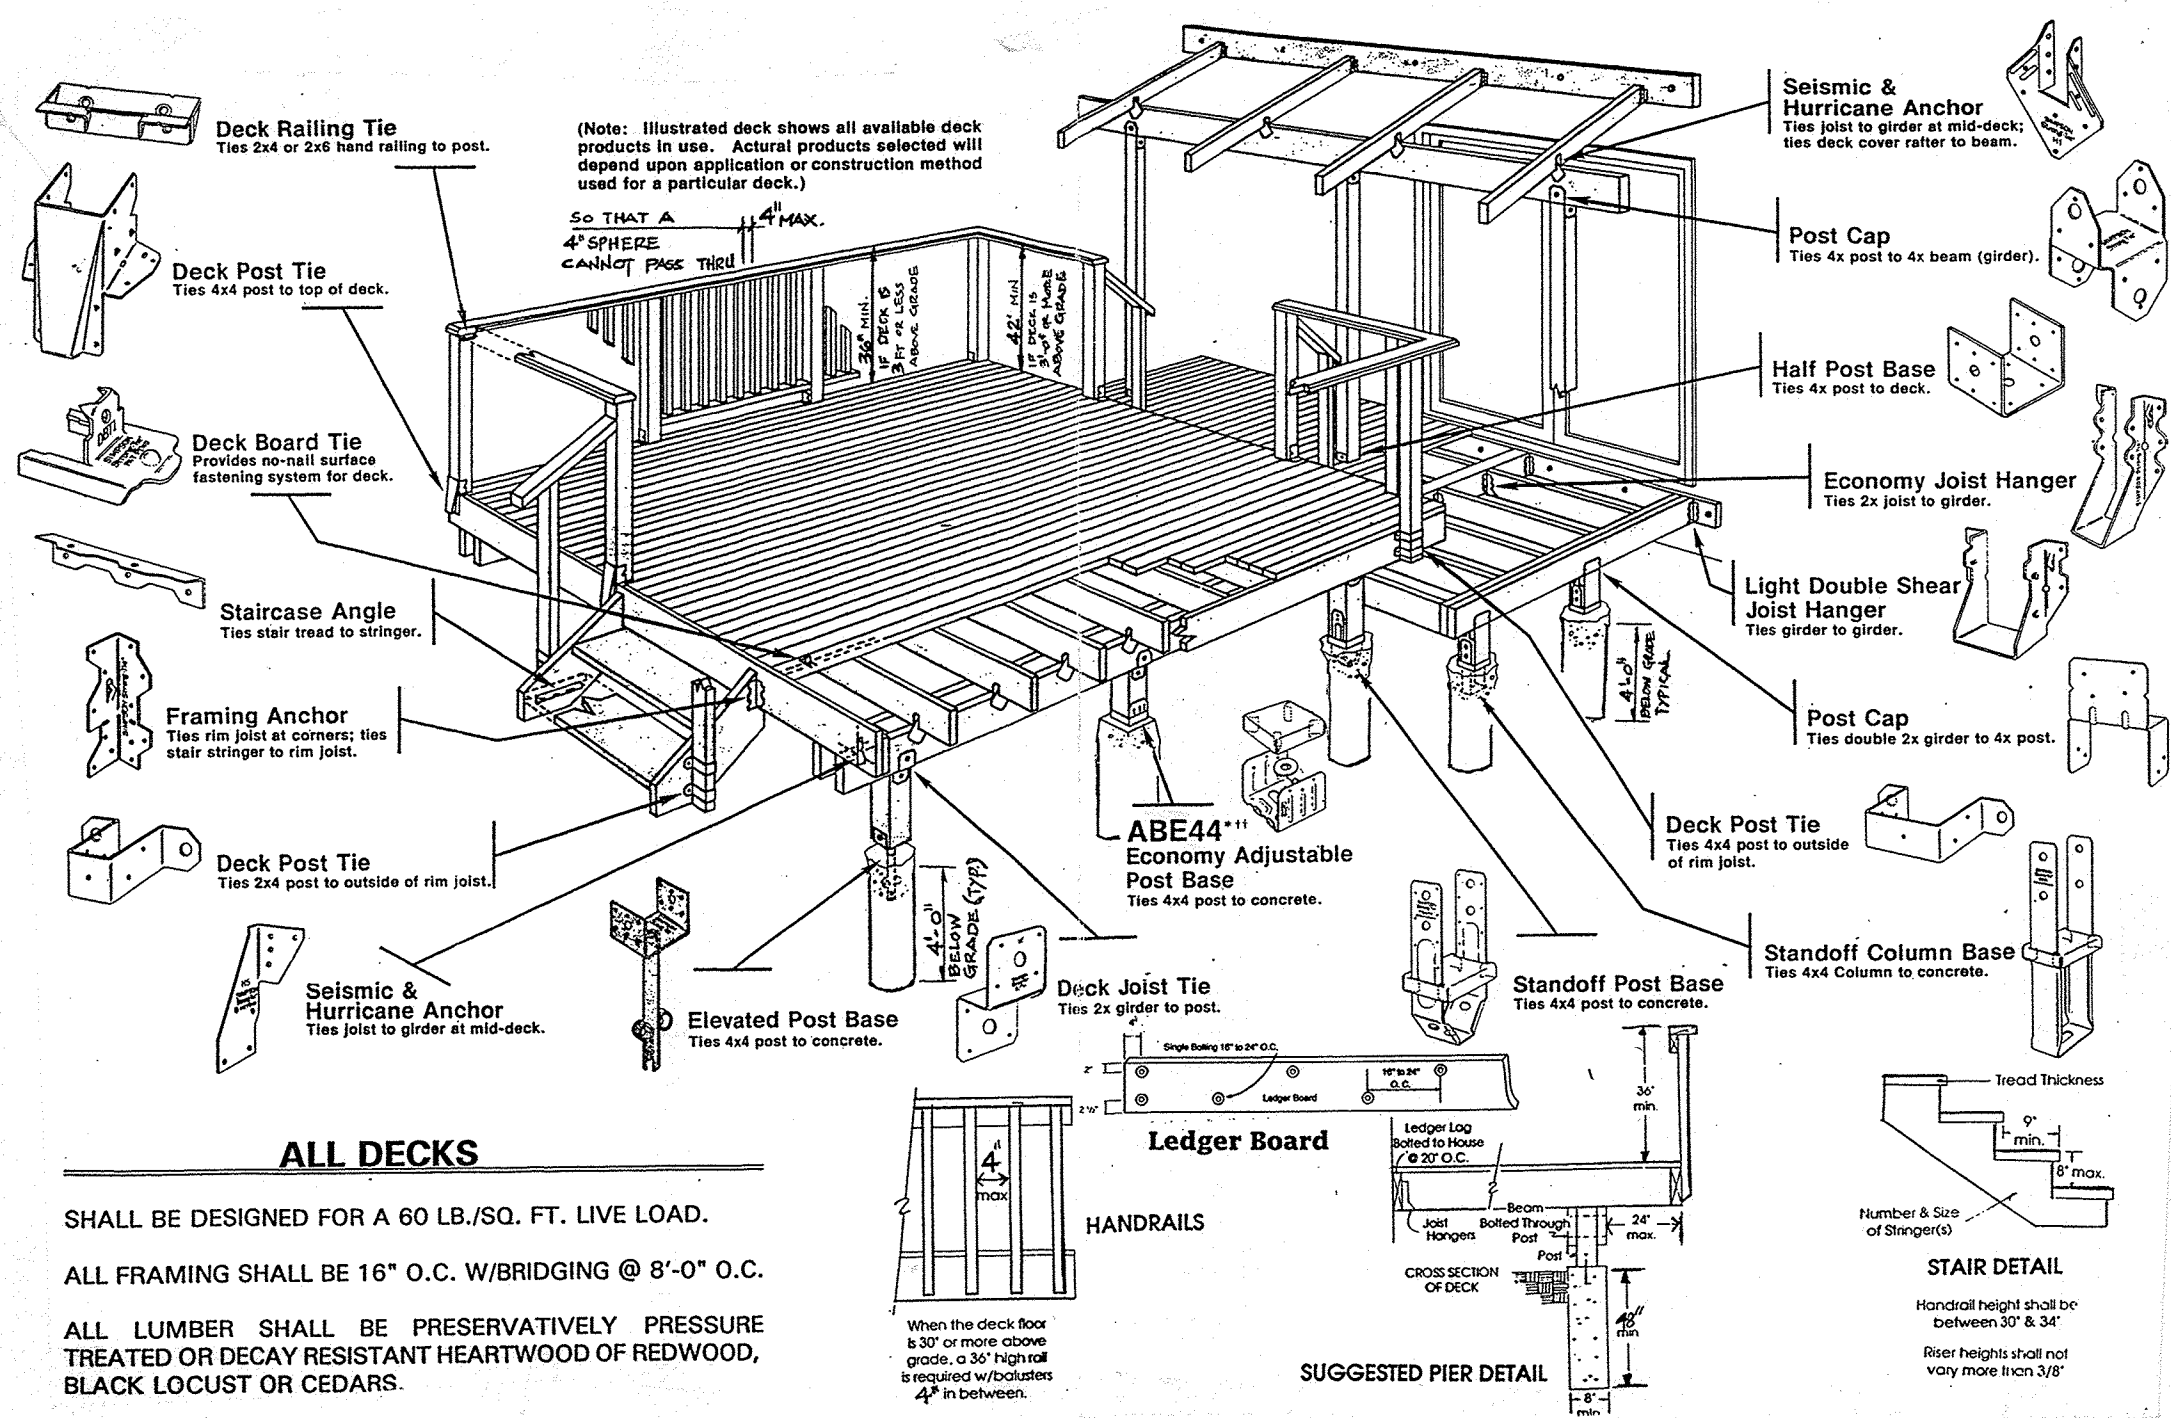

Fixture Type	Unit	Number of Fixtures	Fixture Load
Water Closet	3	x 3	= 9
Lavatory	1	x 4	= 4
Bath/Shower	2	x 4	= 8
Kitchen Sink / W.B.K.	2	x 2	= 4
Dishwasher	1	x 1	= 1
Laundry Sink	3	x 1	= 3
Laundry Machine	2	x 1	= 2
Total Fixture Load			= 31


Water Service Pipe Size Req'd. 1 1/2" inch  
Water Meter Size Req'd. 1 1/2" inch




**State of Illinois**  
Nicholas R. DeLuca  
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Licensed architect

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<b>REMODEL &amp; ADDITION</b> <b>SUE &amp; BOB ROLES</b> 25 FULTON STREET GENEVA, IL.	
project number: 202026	prepared by: ND
date: 8/28/20	sheet number:
■ WALL SECTIONS ■ TRANSVERSE SECTIONS ■ DECK DETAILS ■ PLUMBING 160 METRICAL	
<b>7</b> OF 10	




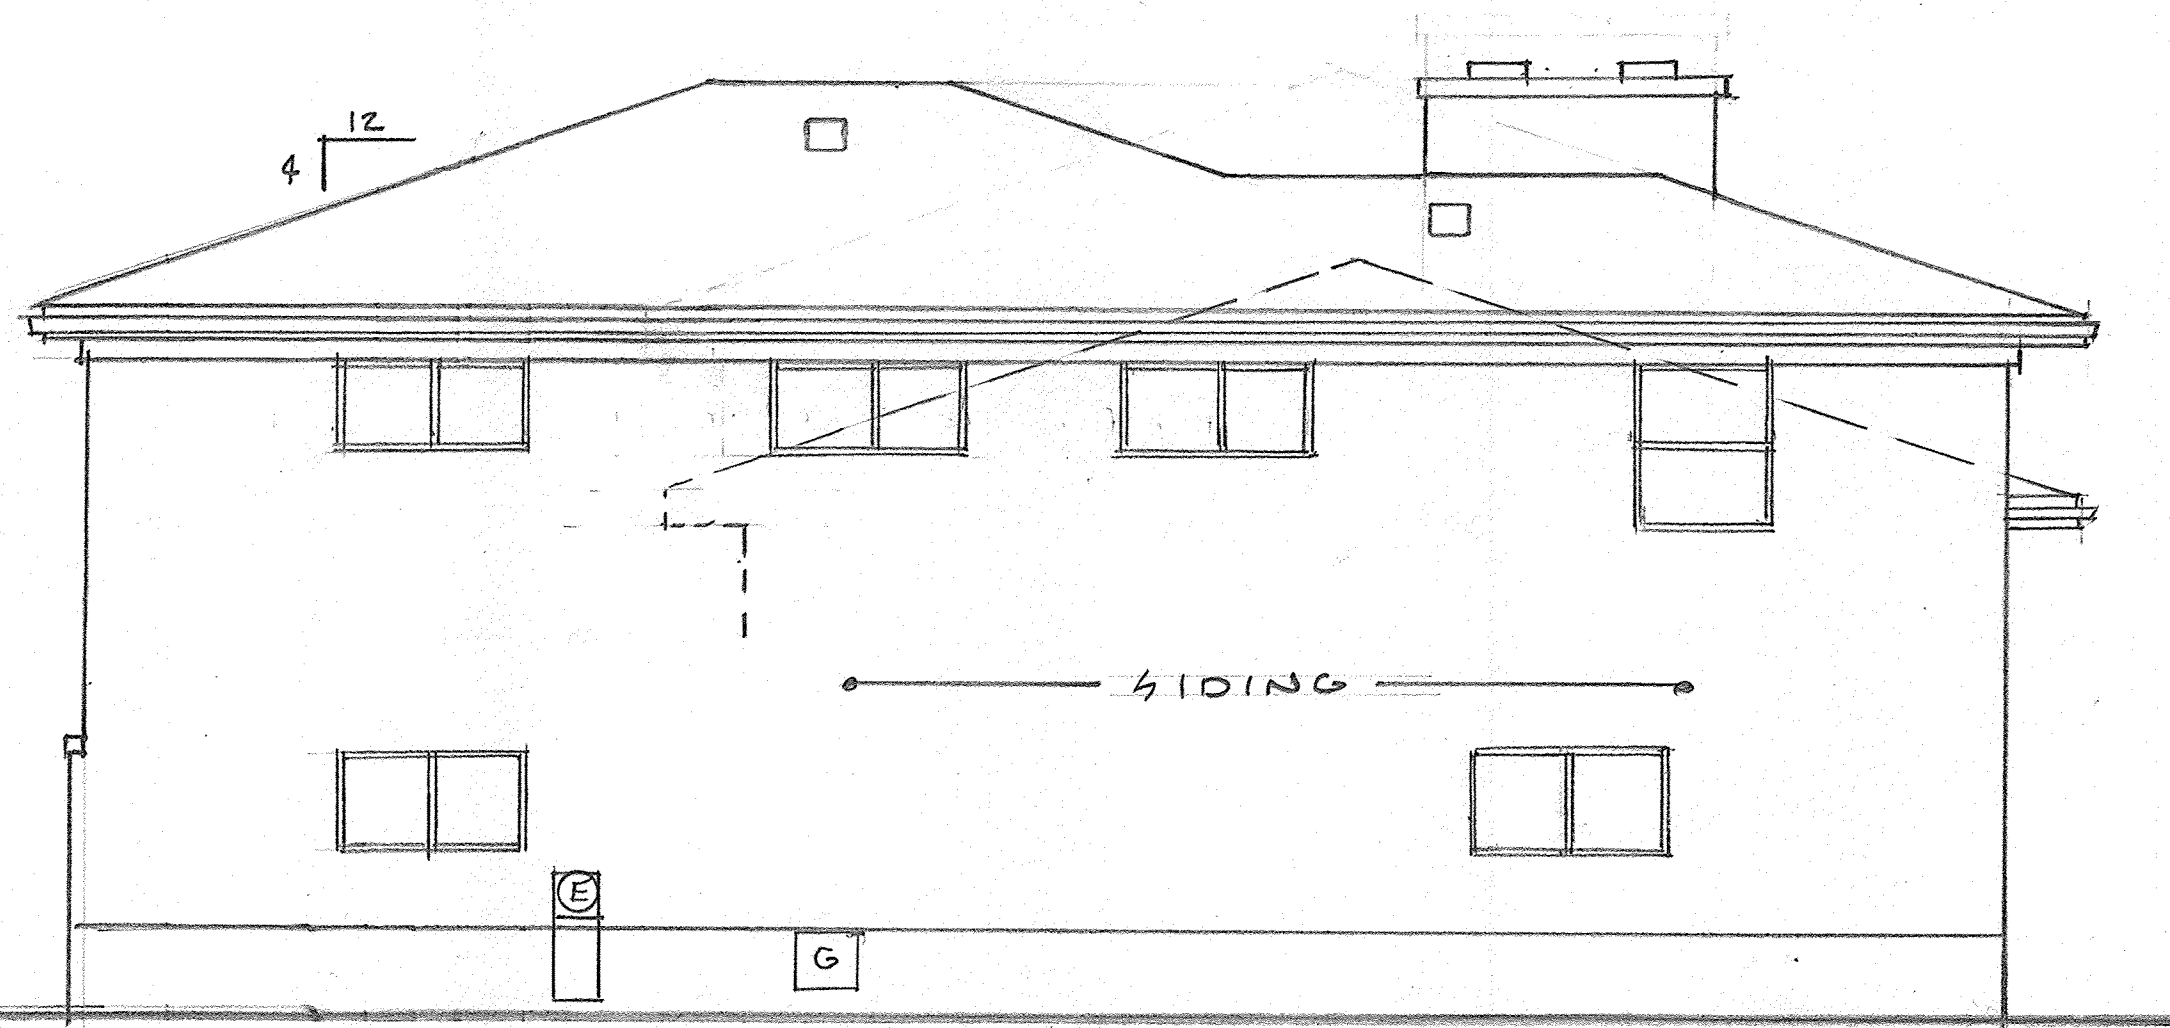


EAST ELEVATION 1/4"=1'-0"

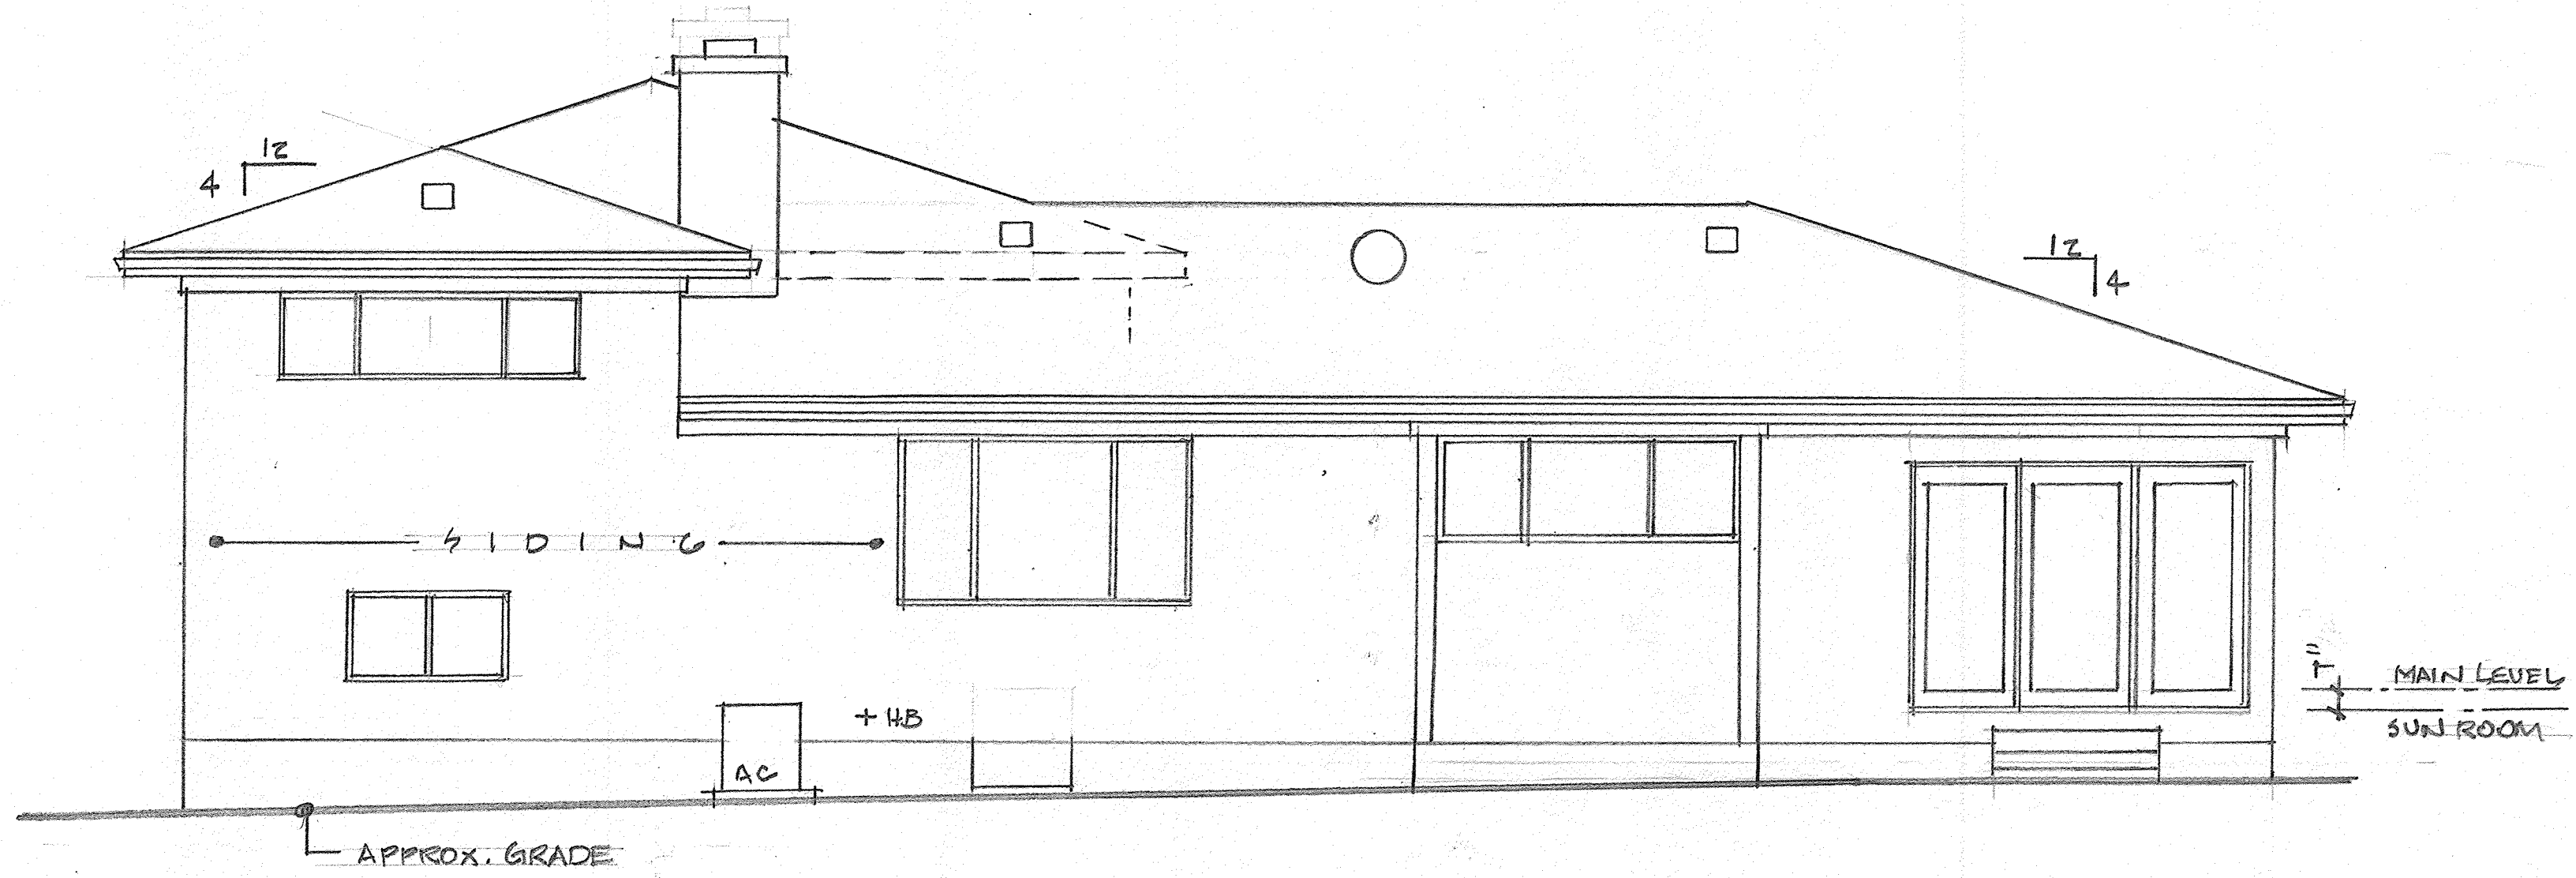

NORTH ELEVATION 1/4"=1'-0"

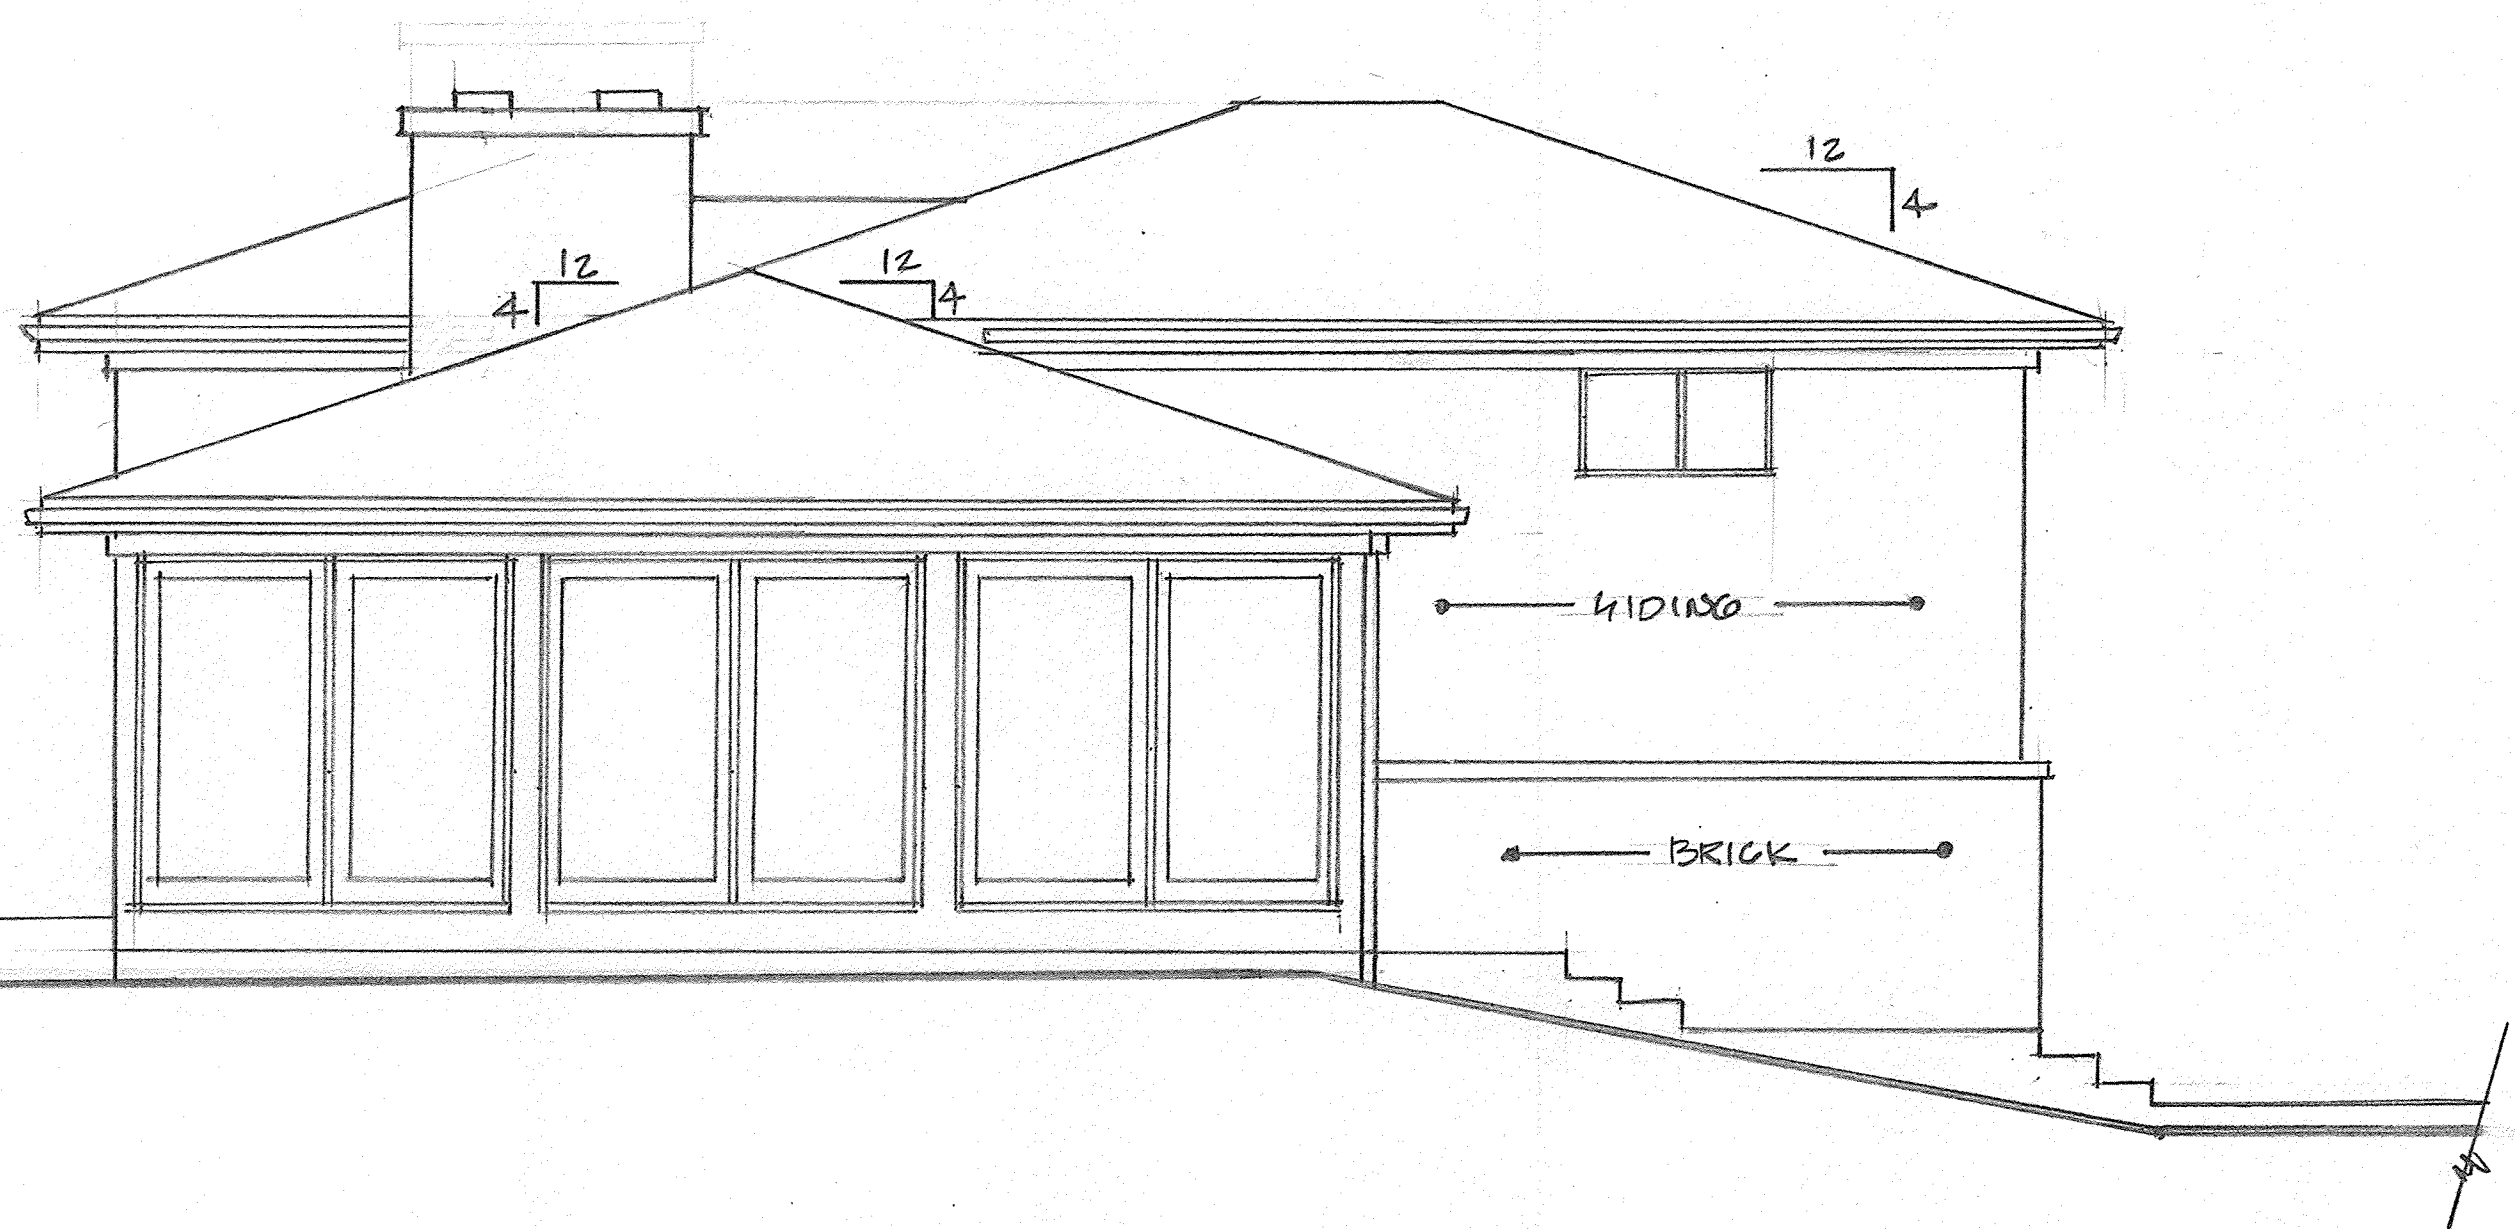

WEST ELEVATION 1/4"=1'-0"

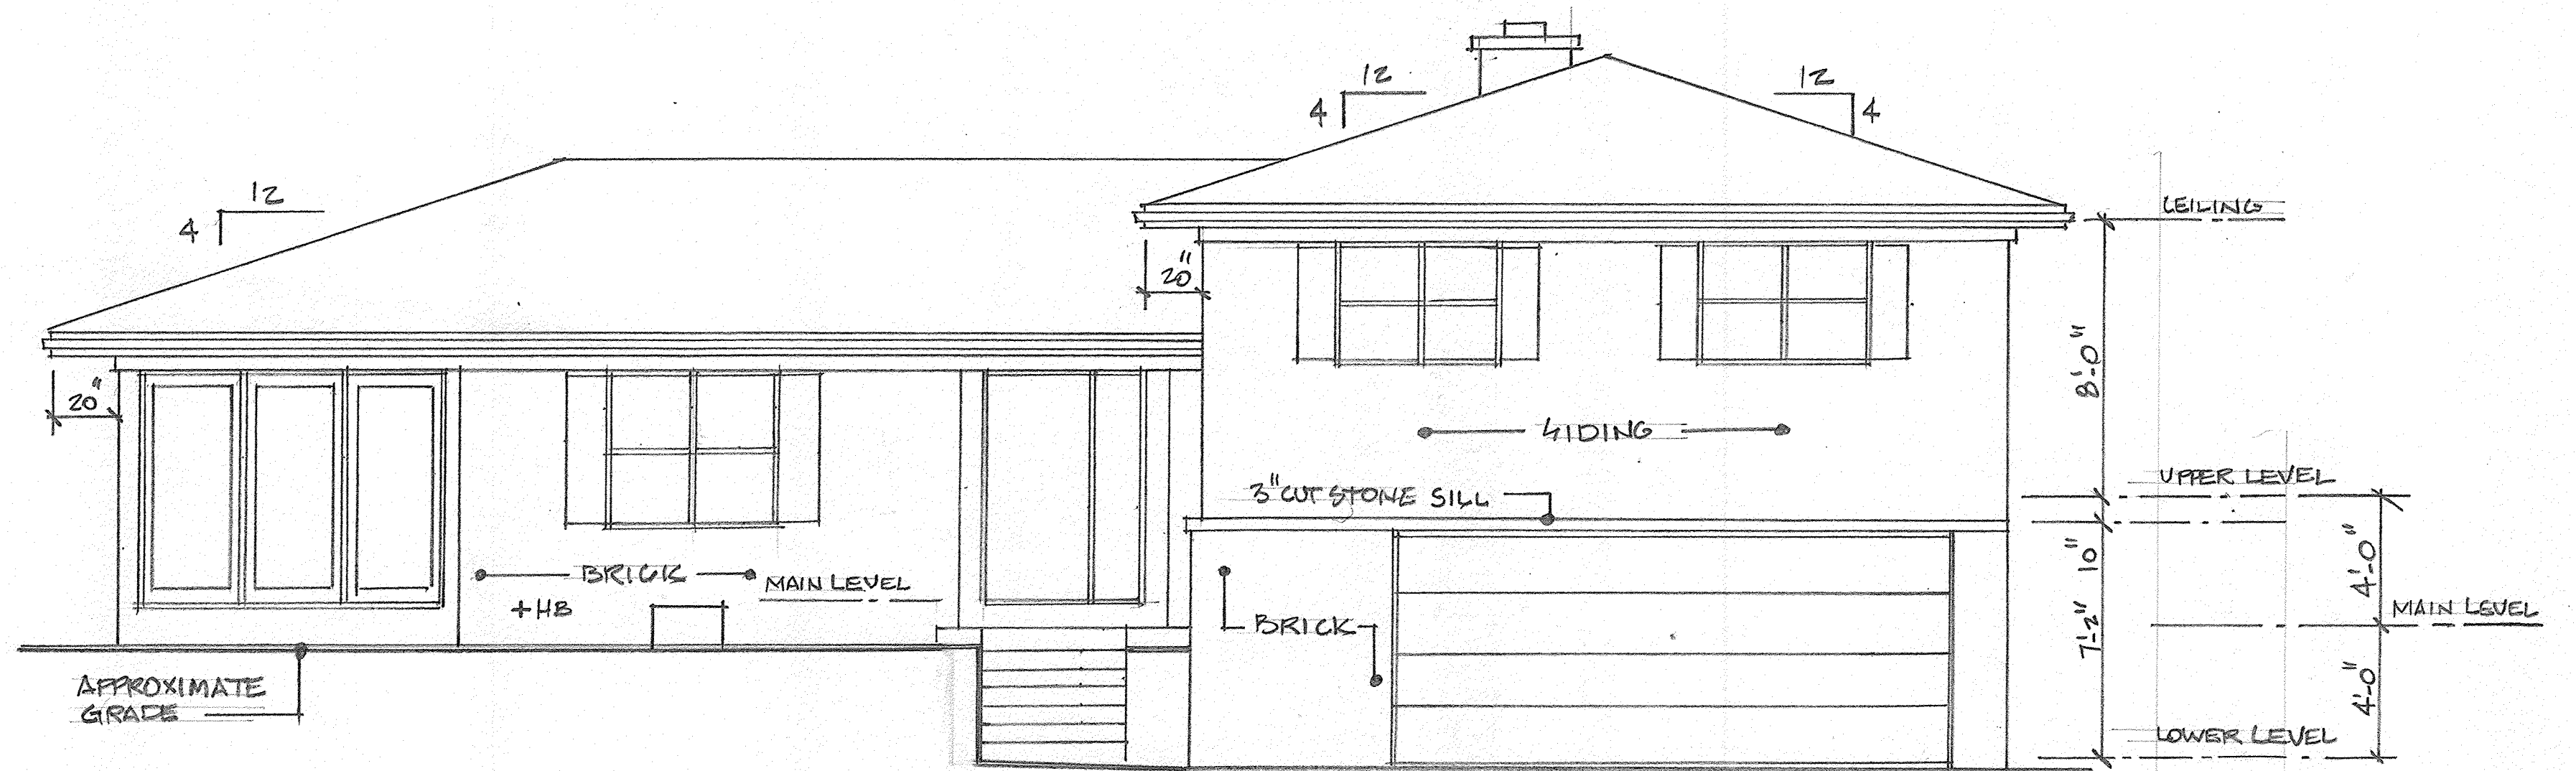


SOUTH ELEVATION 1/4"=1'-0"

State of Illinois  
 Nicholas R. DeLuca  
 001.006810  
 Licensed architect


EXISTING

Issued for permit:	Issued for construction:
<b>ND</b> Nicholas R. DeLuca 1807 West Diehl Road, Suite 200 Naperville, IL 60563 (630) 637-8213	architect
REMODEL & ADDITION SUE & BOB ROLES	project number: 202026
25 FULTON STREET GENEVA, IL.	prepared by: ND
EXISTING EXTERIOR ELEVATIONS	date: 8/28/20
	sheet number: 8 OF 10



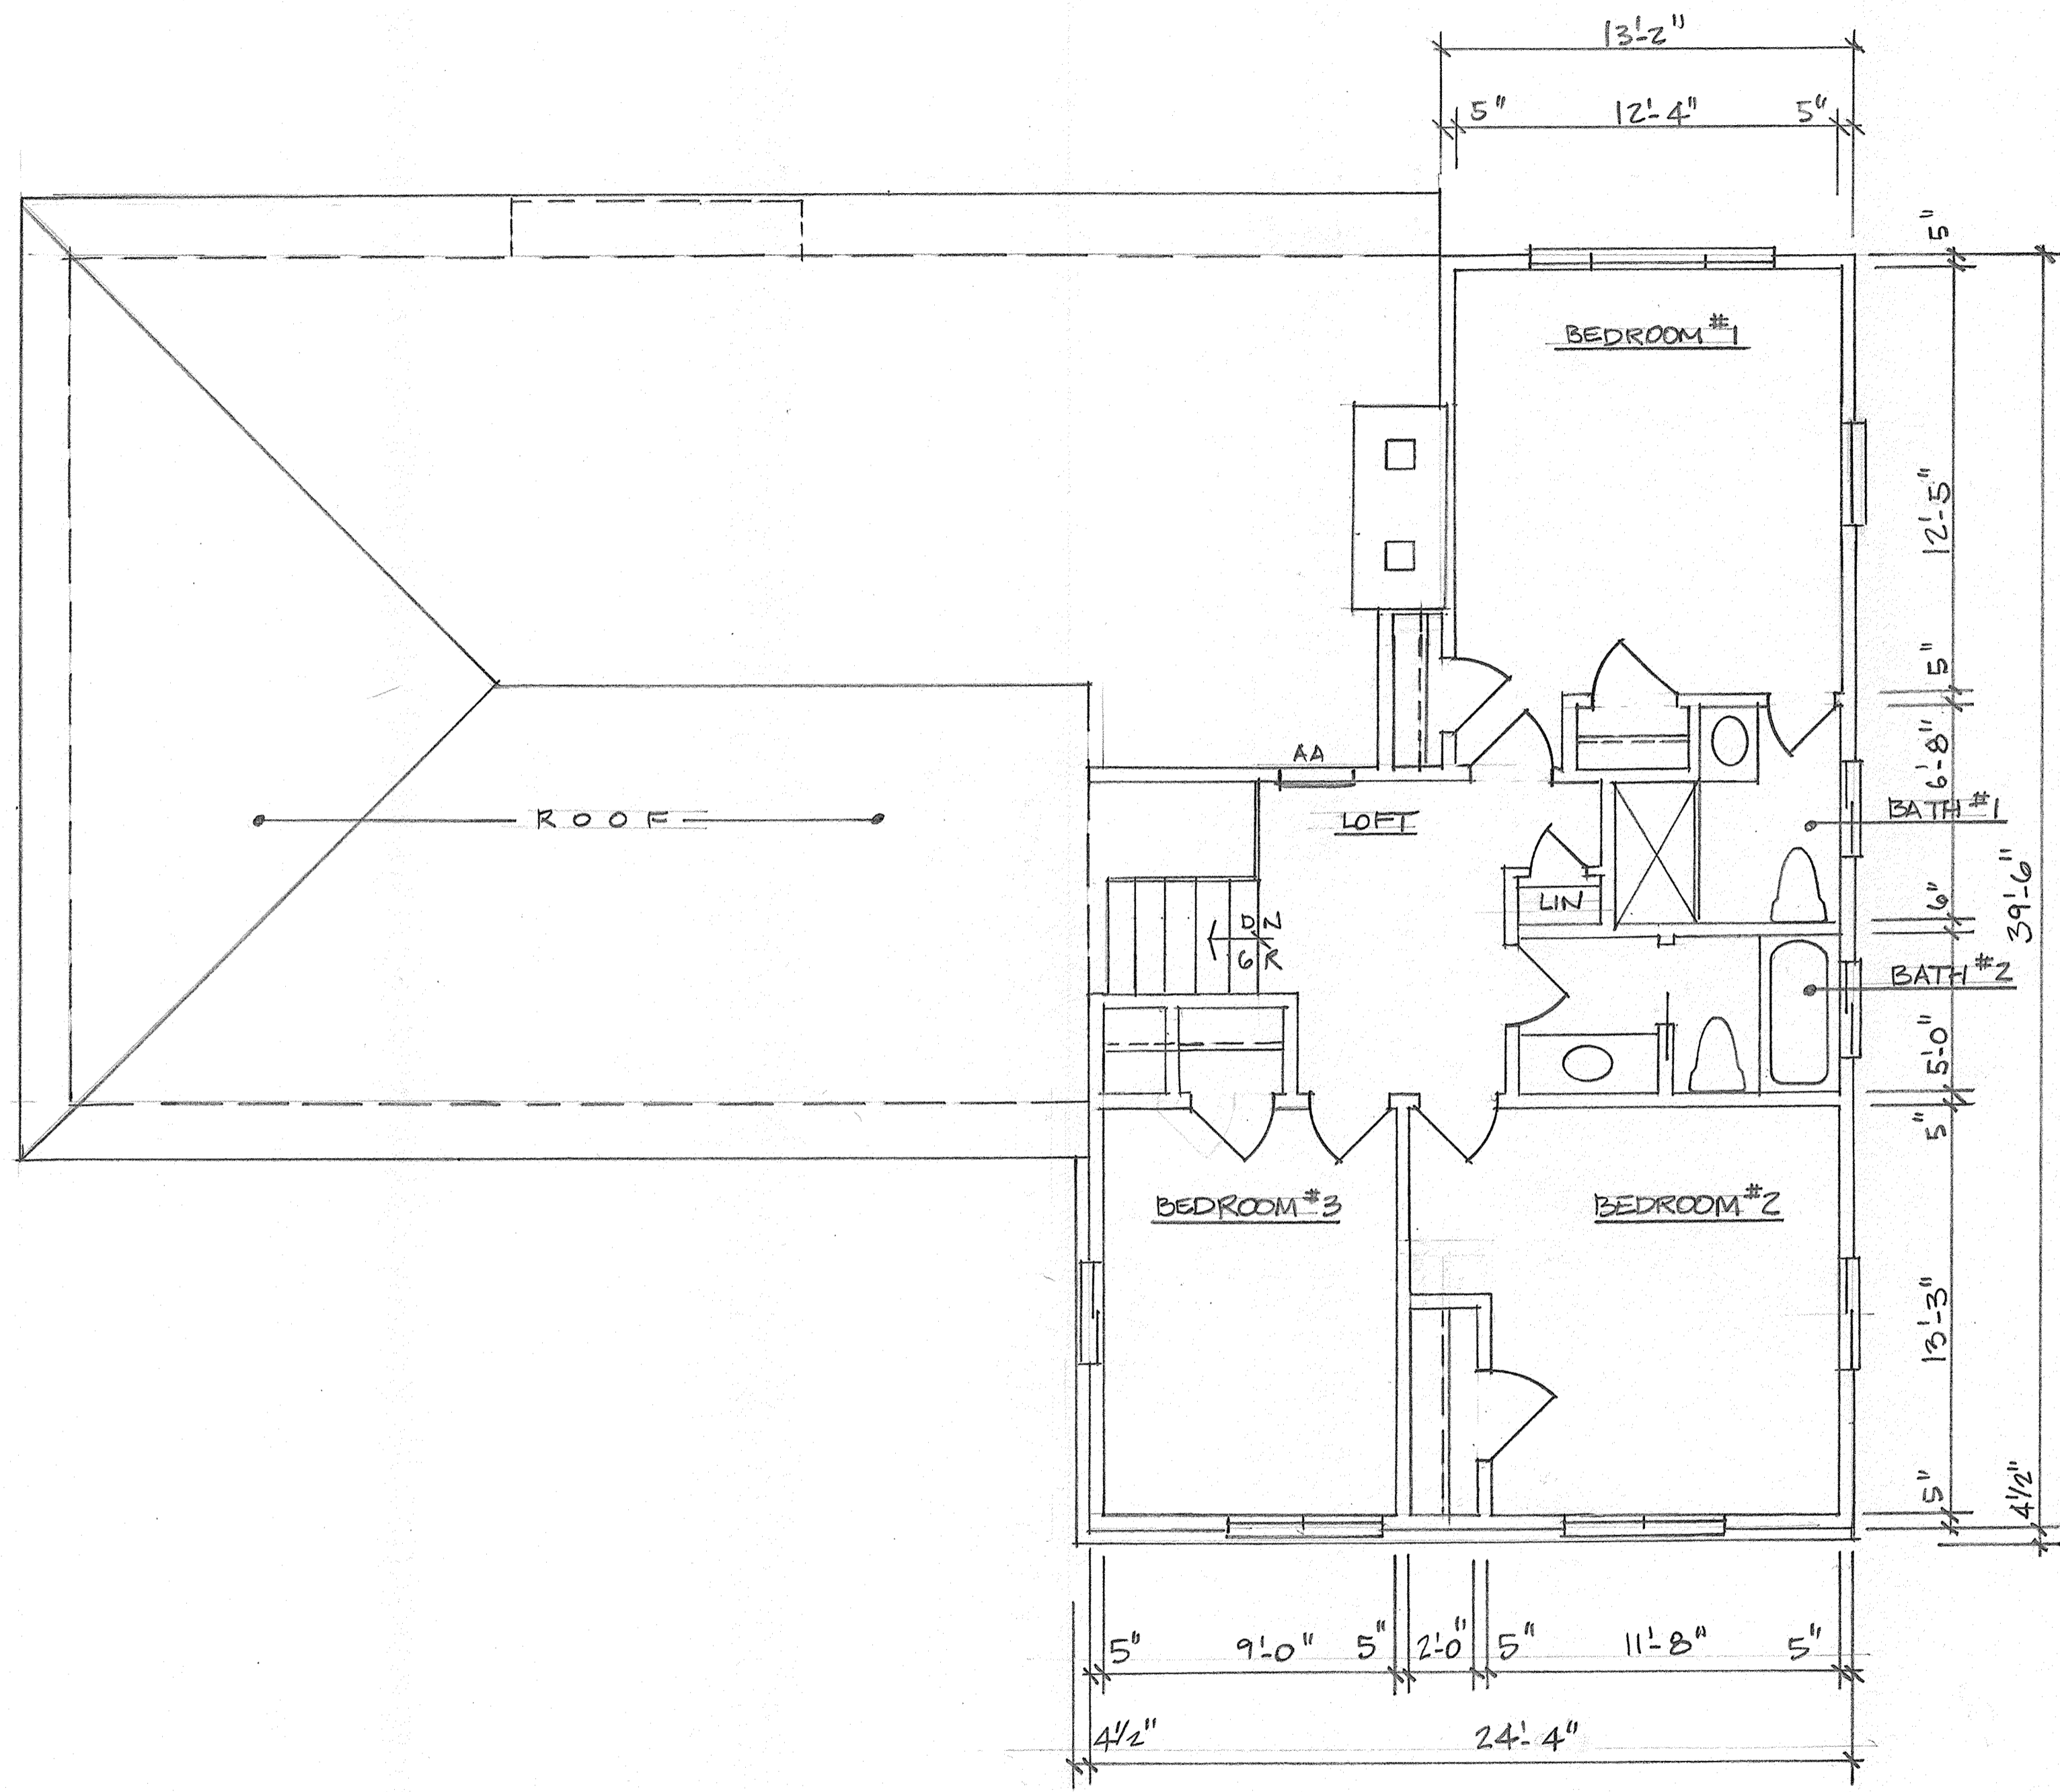


UPPER LEVEL FLOOR PLAN 1/4"=1'-0"

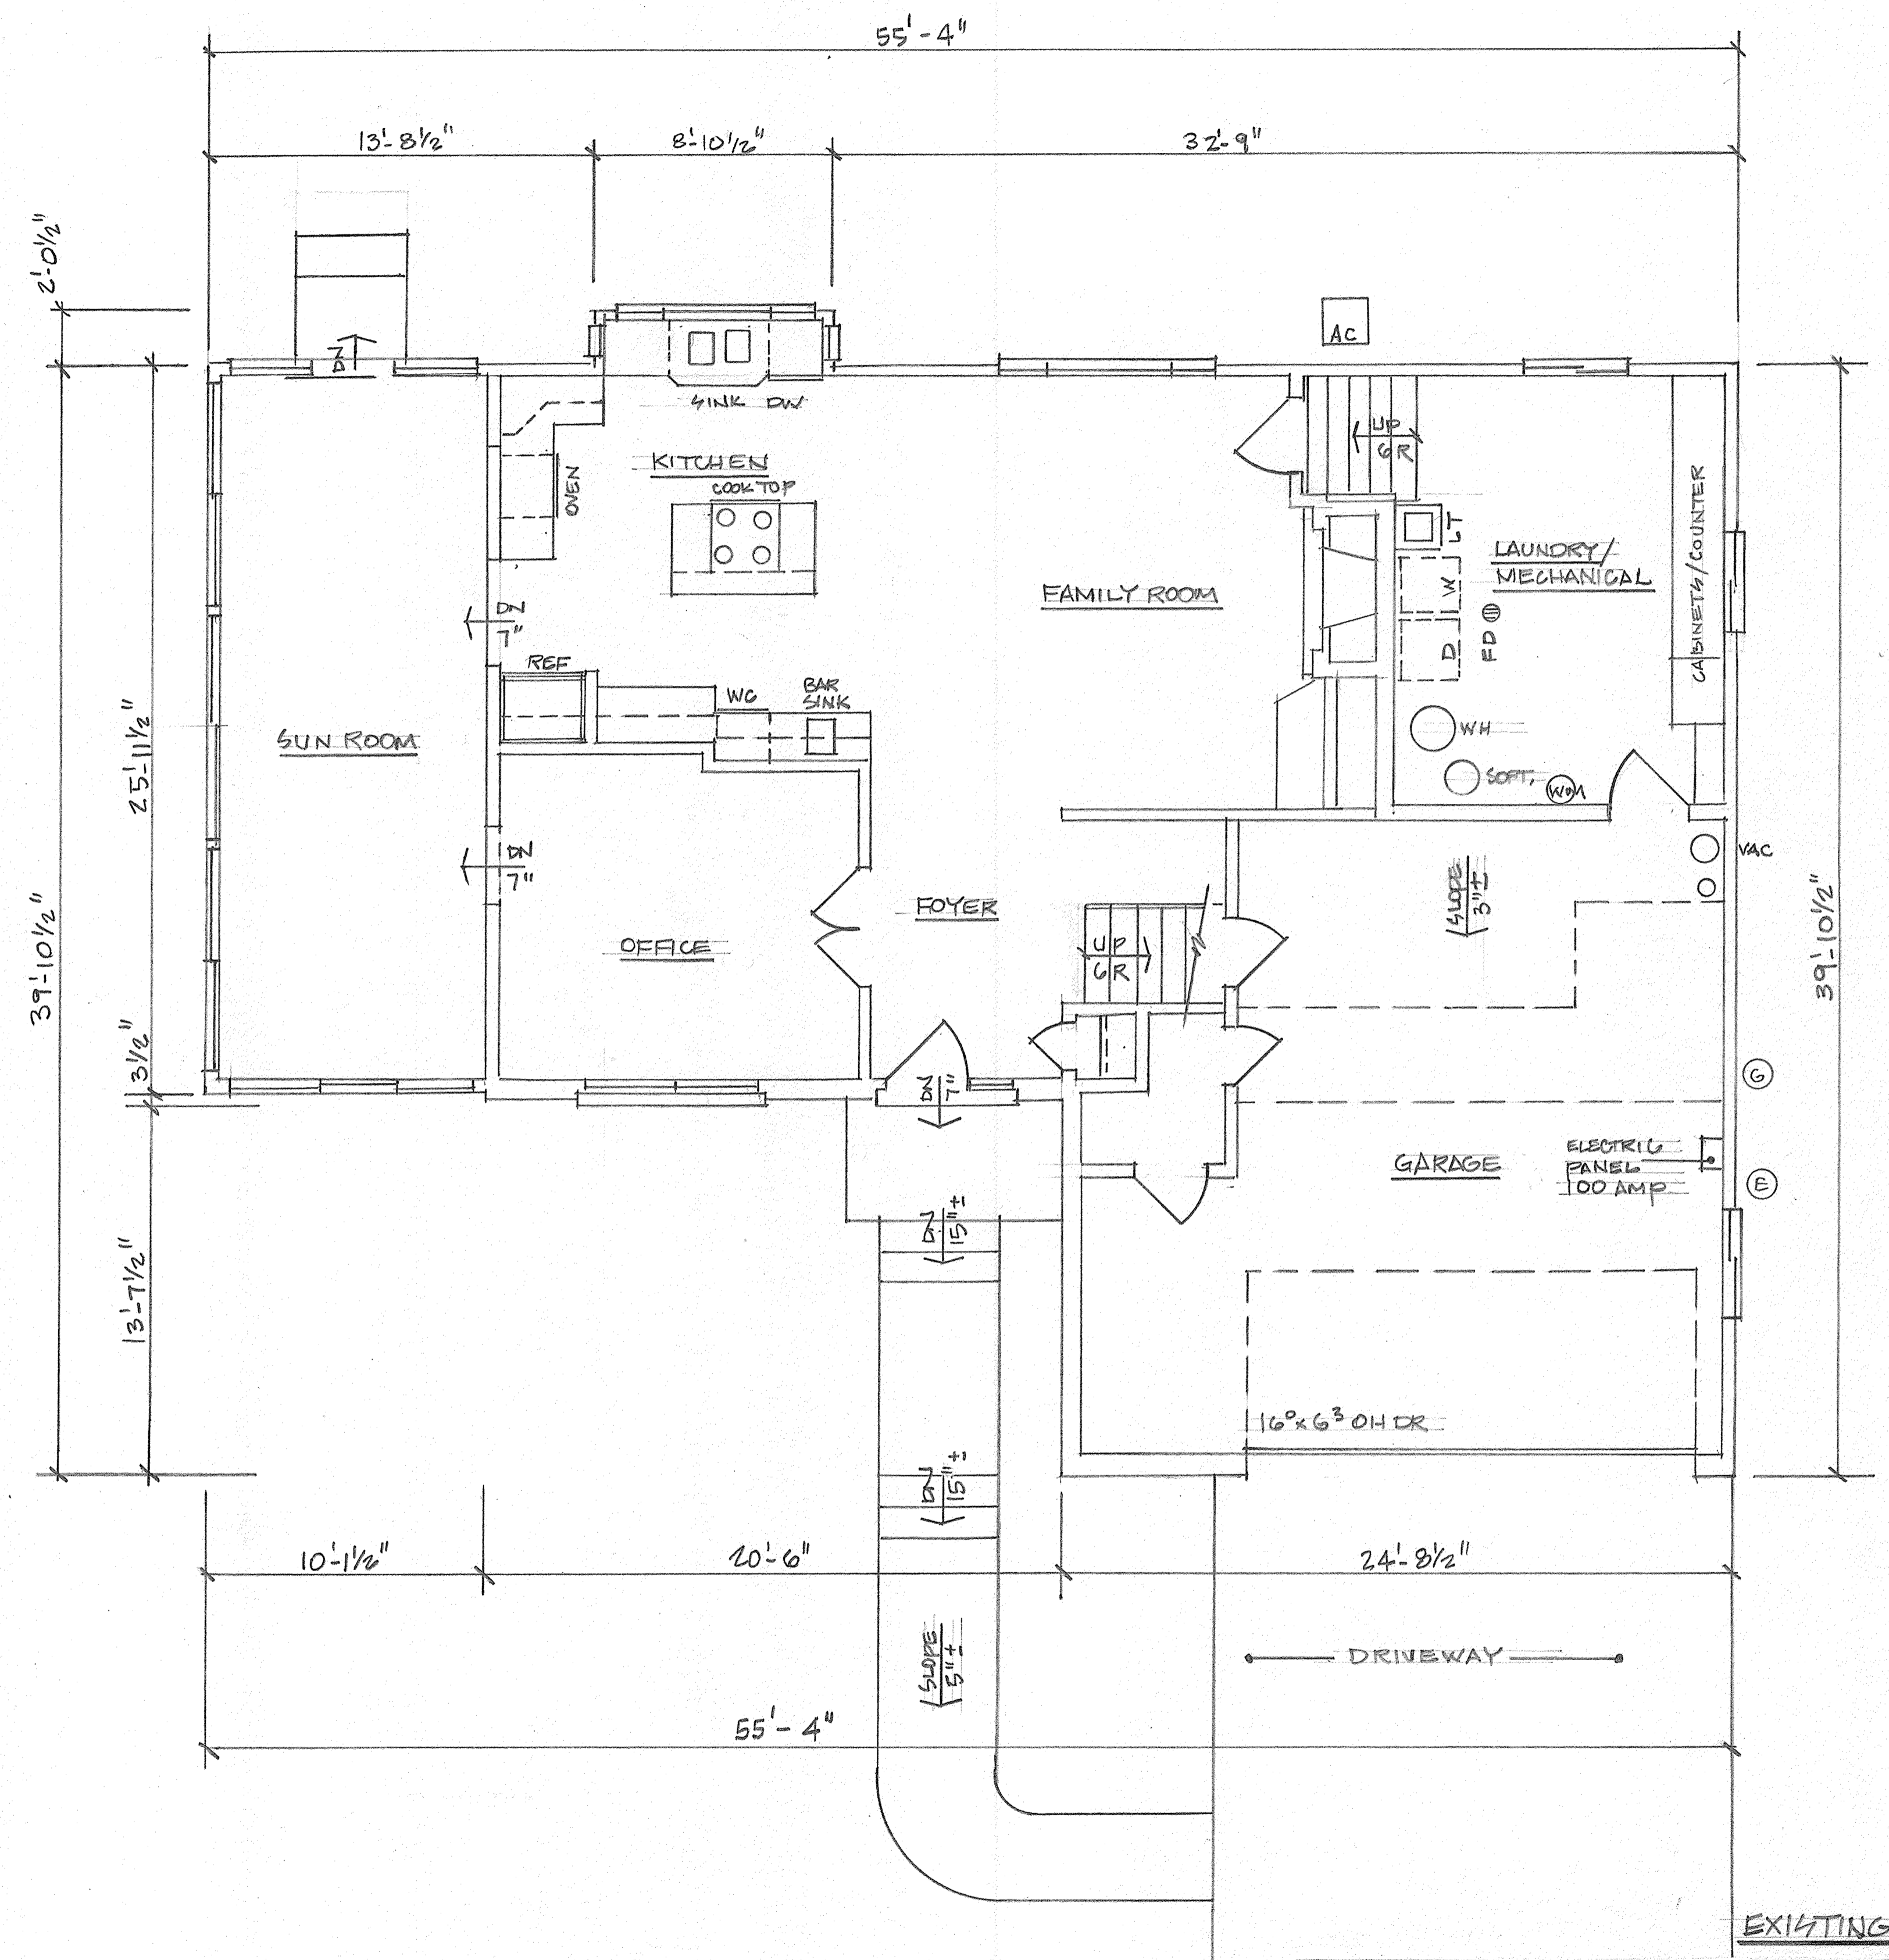


MAIN & LOWER LEVEL FLOOR PLAN 1/4"=1'-0"

State of Illinois  
 Nicholas R. DeLuca  
 001.006810  
 Licensed architect

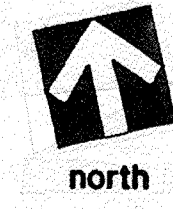


Issued for permit:	Issued for construction:
<b>ND</b> Nicholas R. DeLuca 1807 West Diehl Road, Suite 200 Naperville, IL 60563	architect (630) 637-8213
REMODEL & ADDITION <b>SUE &amp; BOB BOLES</b> 25 FULTON STREET GENEVA, IL.	
project number: 202026	prepared by: ND
date: 8/28/20	sheet number: 9 OF 10
■ MAIN & LOWER LEVEL PLANS ■ UPPER LEVEL FLOOR PLAN	



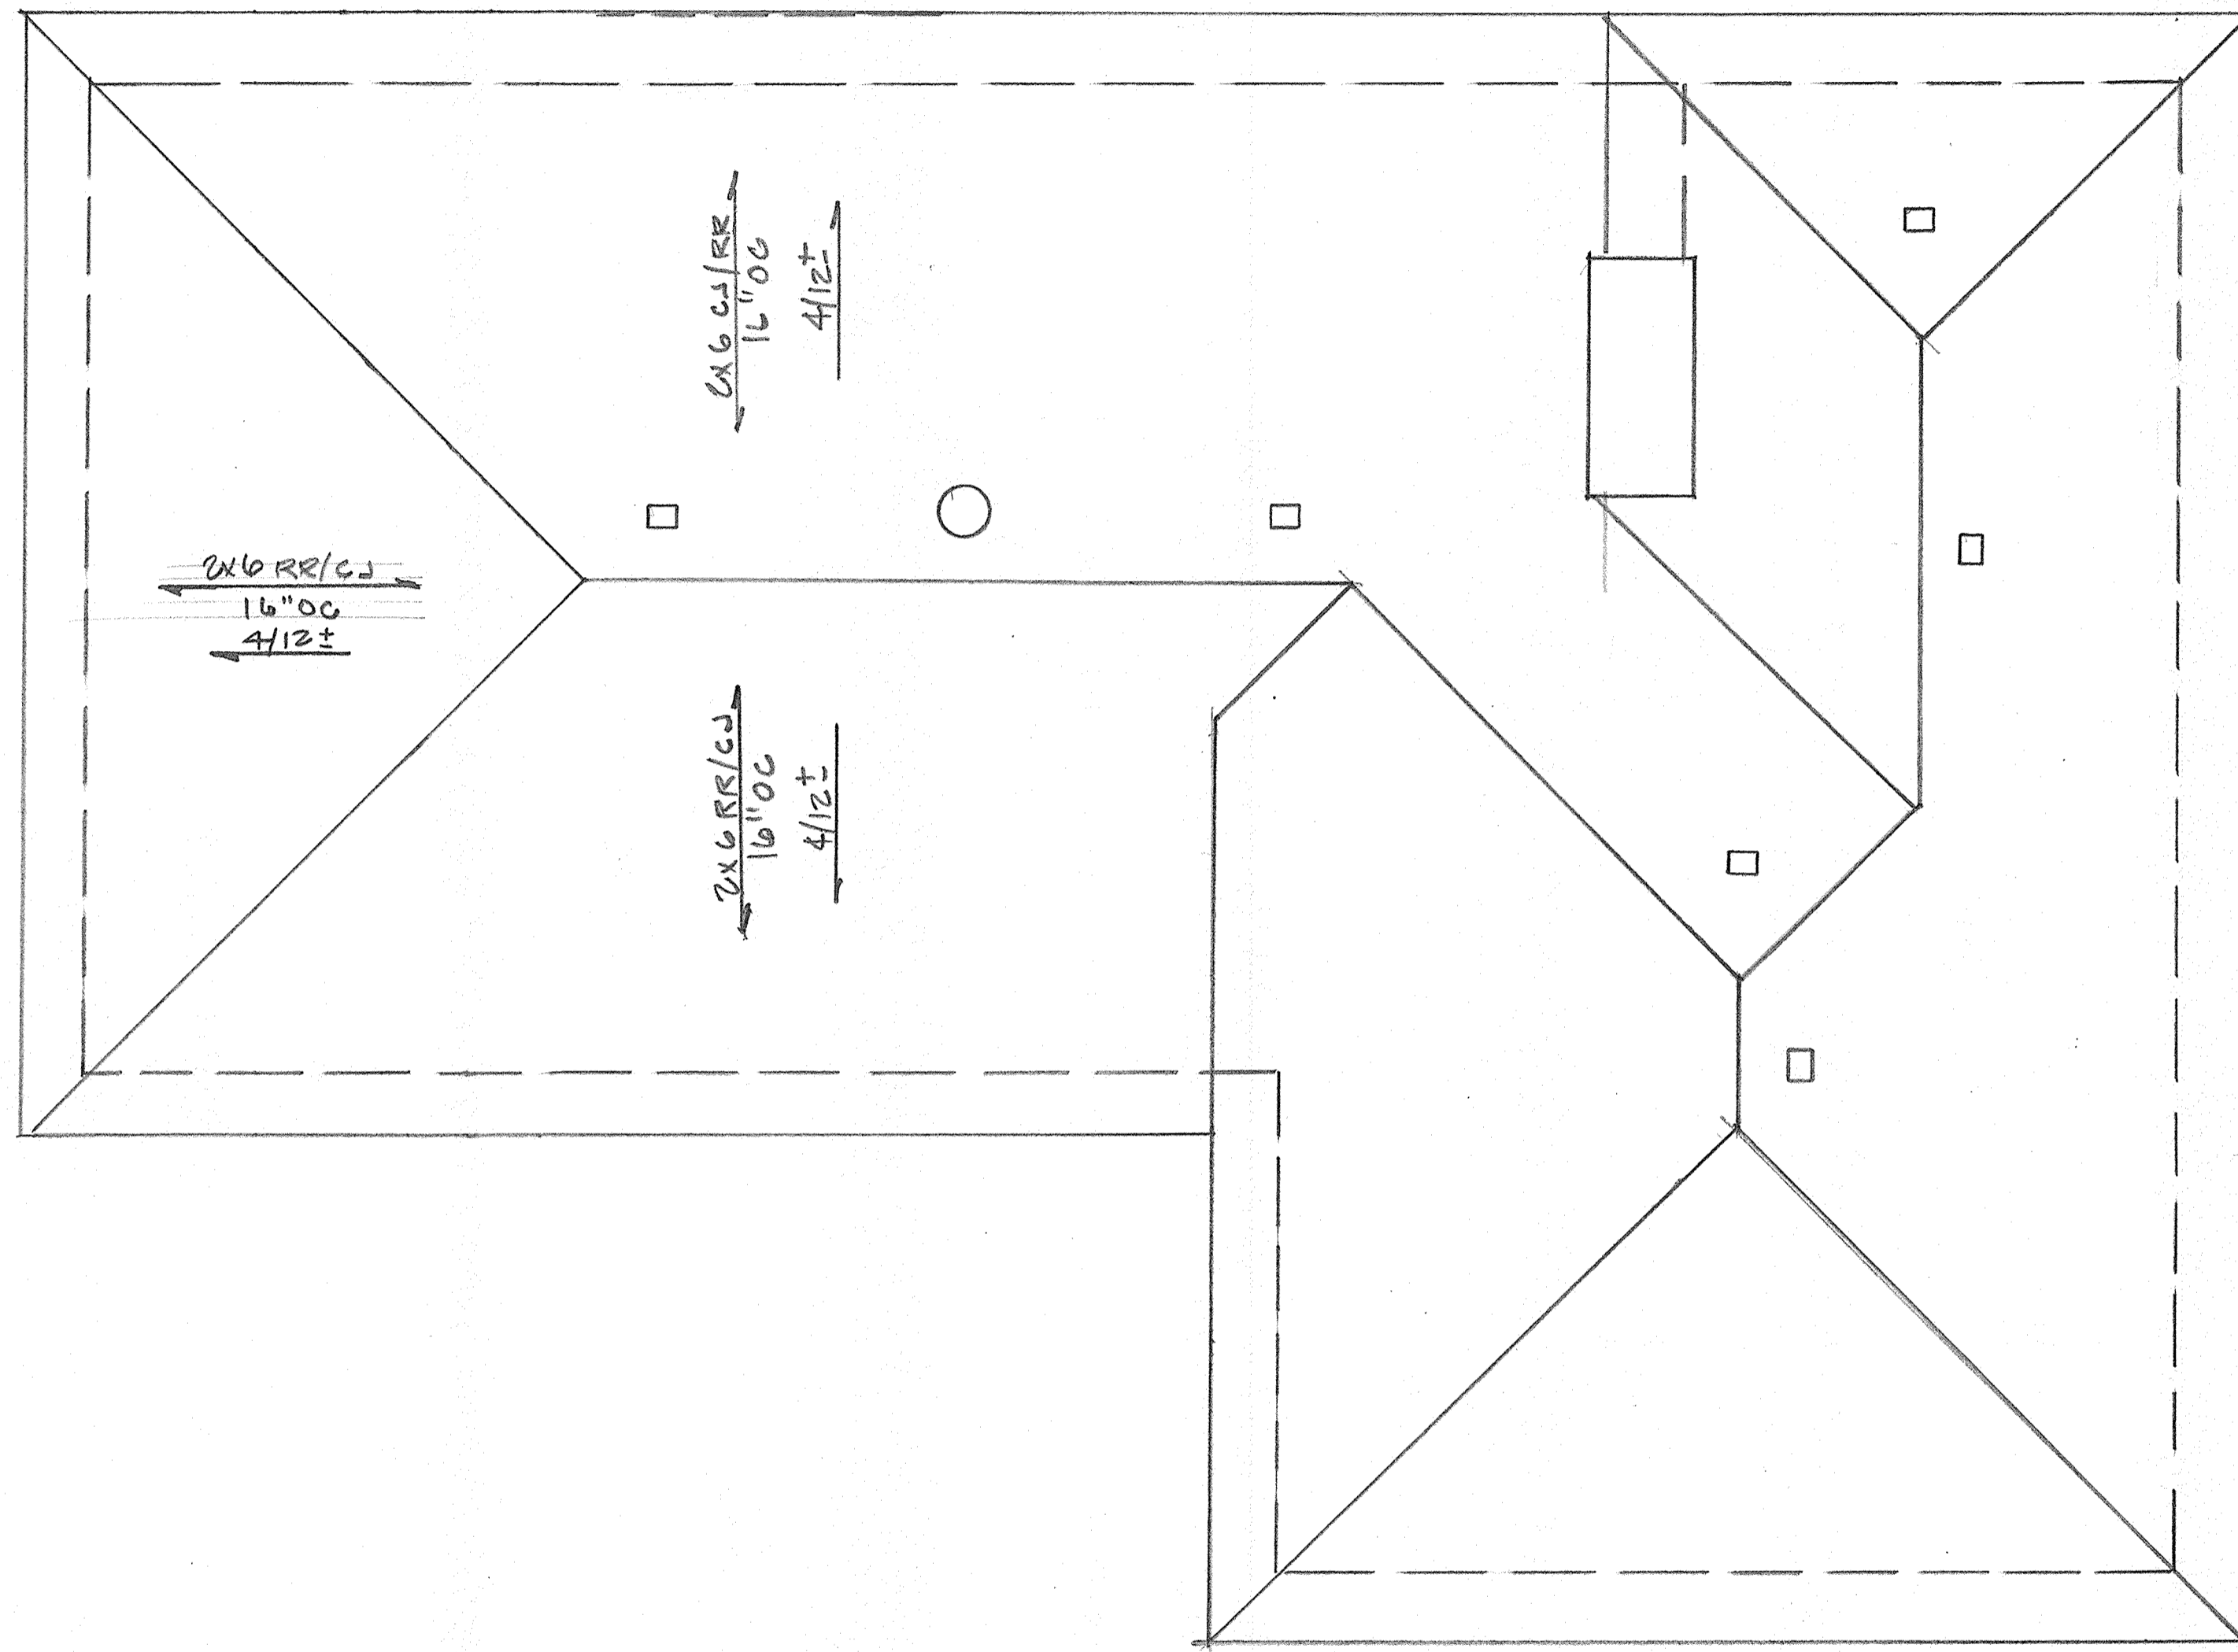


ROOF PLAN 1/4"=1'-0"

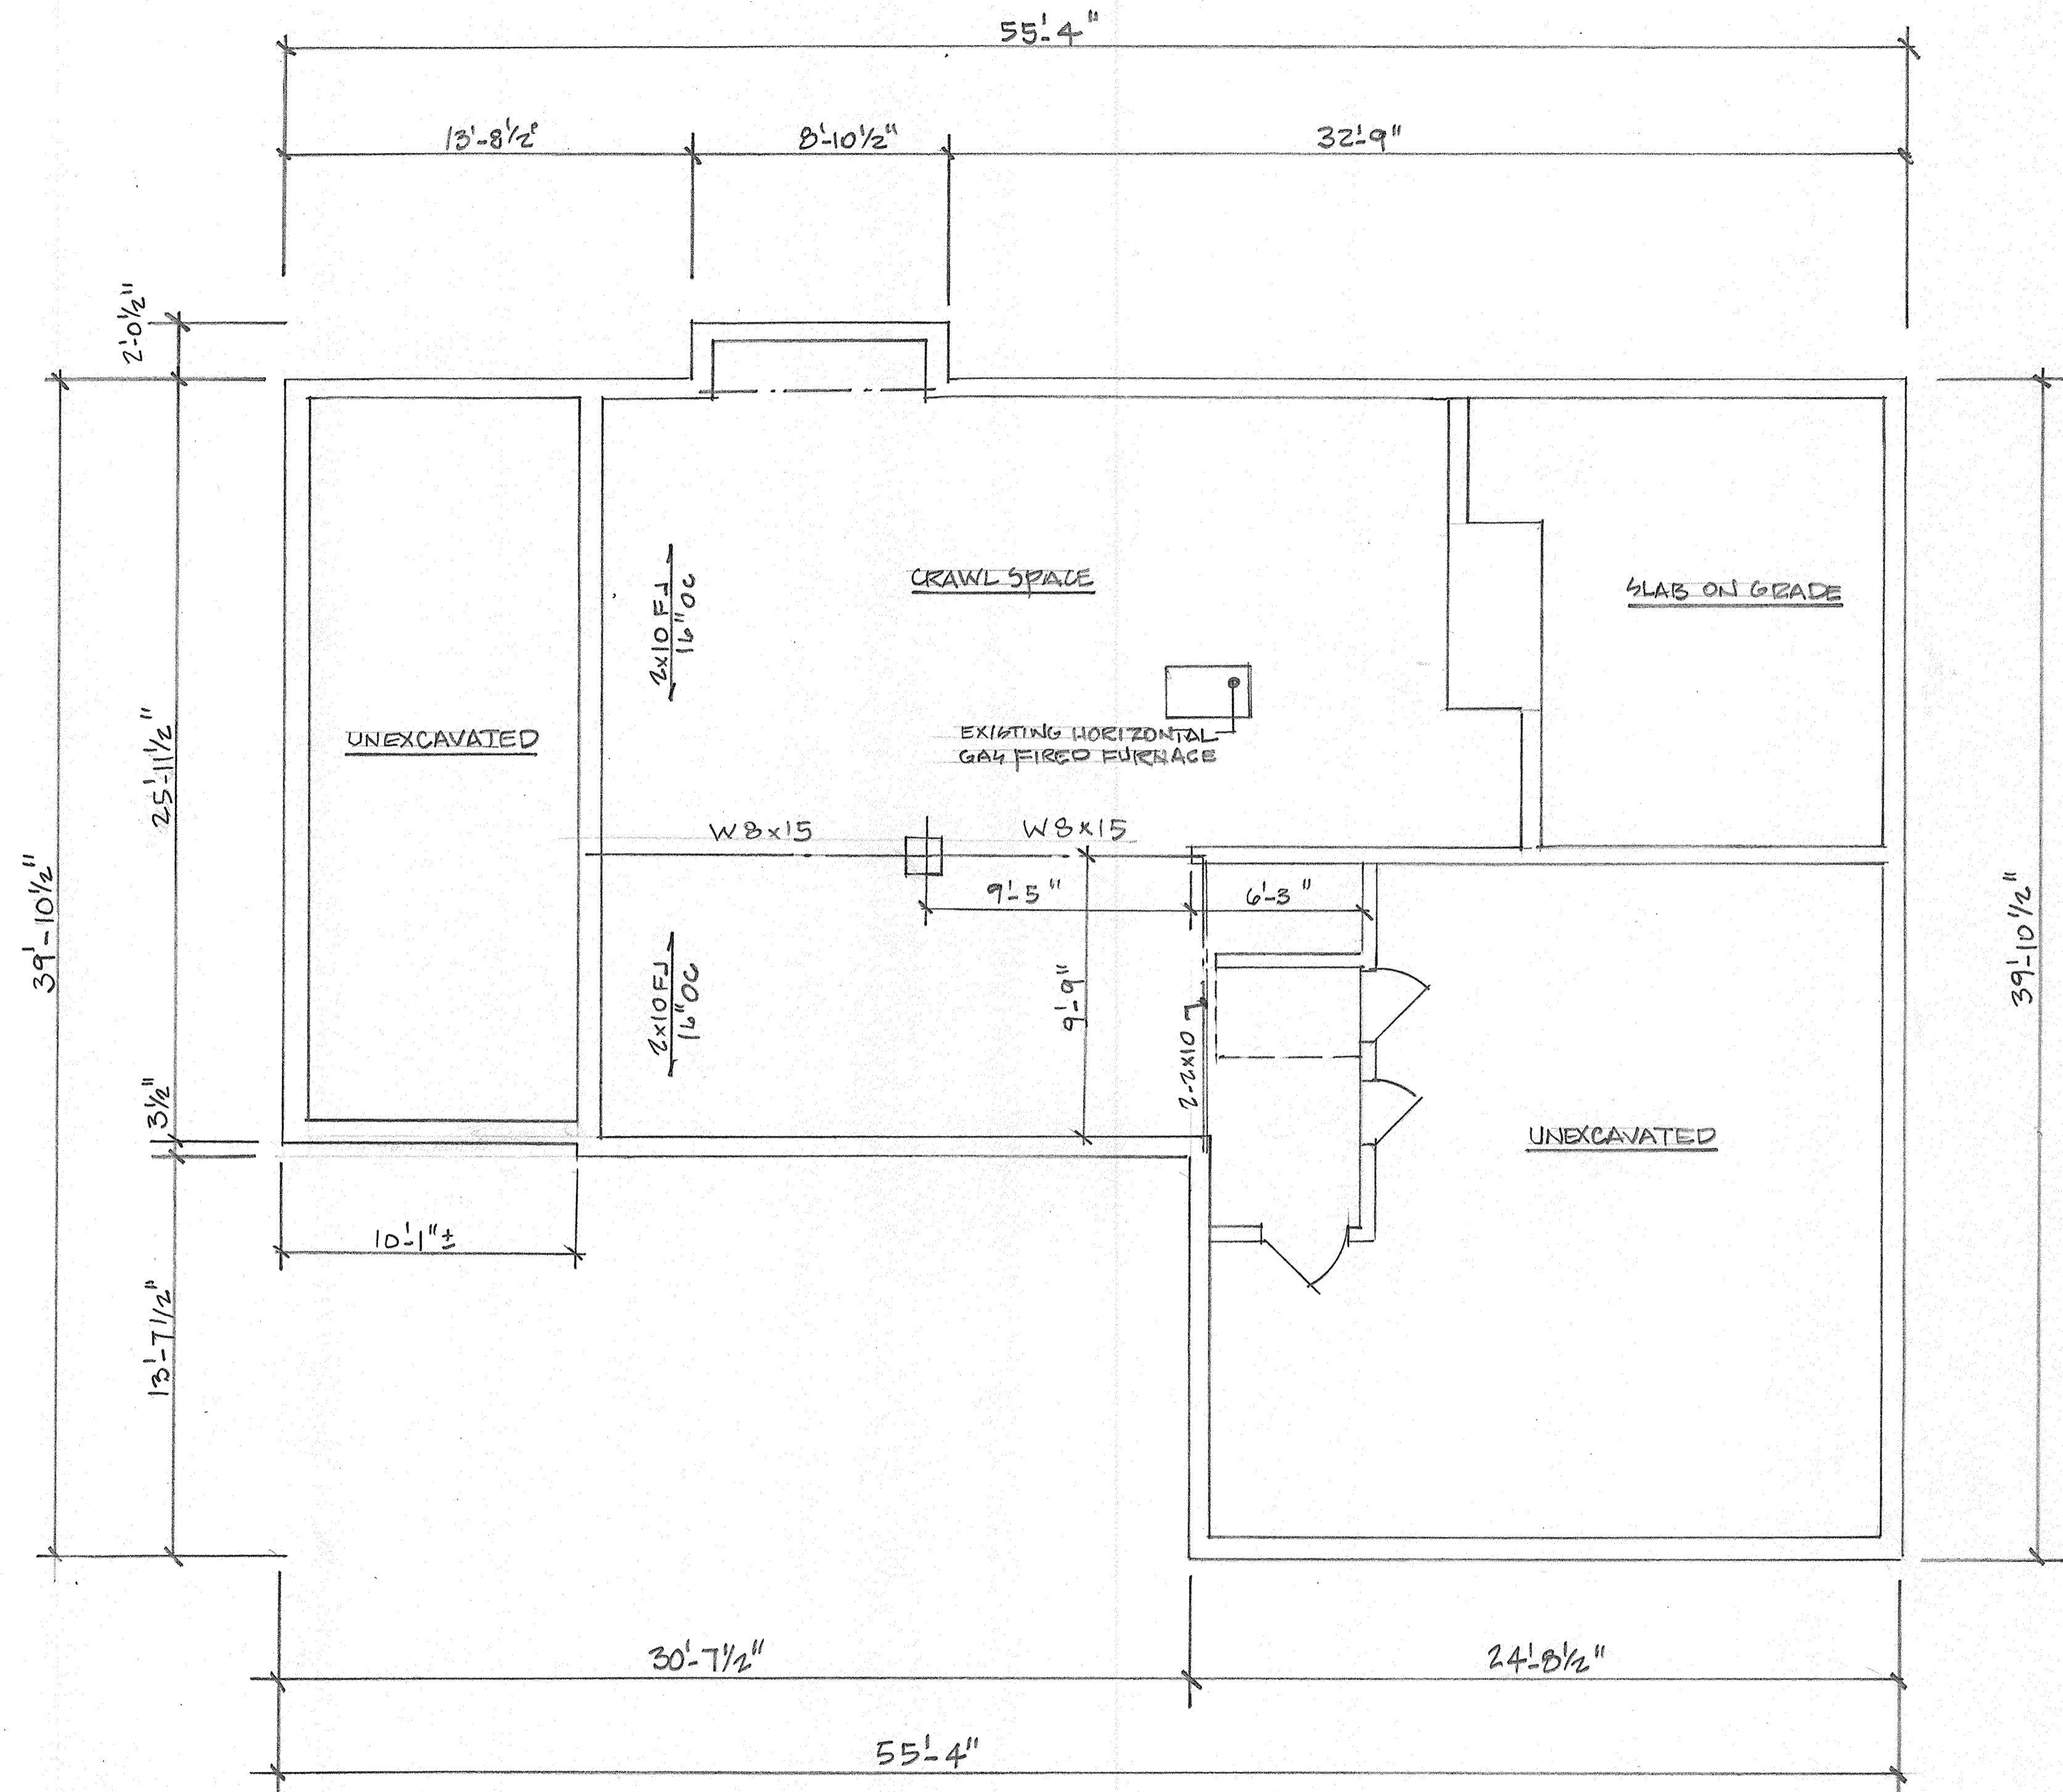

FOUNDATION PLAN 1/4"=1'-0"

EXISTING

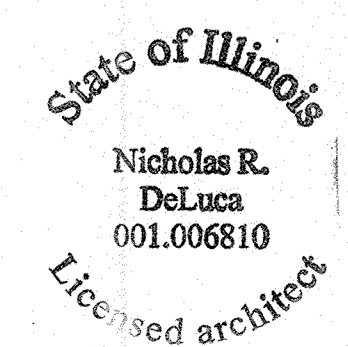

Issued for permit:	Issued for construction:
<b>ND</b> Nicholas R. DeLuca 1807 West Diehl Road, Suite 200 Naperville, IL 60563	architect (630) 637-8213
REMODEL & ADDITION SUE & BOB ROLES	project number: 202026
25 FULTON STREET GENEVA, IL.	prepared by: ND
	date: 8/28/20
EXISTING FOUNDATION PLAN EXISTING ROOF PLAN	sheet number: <b>10</b> OF 10